Tender

for

Renovation of Entrance Wall and Gallery Area at G/F

at

Hong Kong Chu Hai College 80 Castle Peak Road, Tuen Mun, N.T.

Tender Document Ref.: HKCHC-TD-GF-EW&GA-20240507(r)

Hong Kong Chu Hai College in all parts of SOR

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Hong Kong Chu Hai College in all parts of SOR

Form of Tender

Form of Tender

Form of Tender

Compan Name	ıy	Registration Certificate Number	Date					
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		ses, the Tenderer must give the numbe on certificate here:	r and date of the business					
а		dential addresses of all partners should be						
	: a tende	er is being made by a partnership or an unir	acornorated body, the name					
Notes:								
HONG KO	ONG CH	IU HAI COLLEGE (THE CLIENT)						
FOR								
<u>G/F</u>								
AT								
For RENC	For RENOVAITON OF ENTRANCE WALL & GALLERY AREA							

FORM OF TENDER

To: The Client

- Having inspected the Site, Tender Documents, for the design and execution of the above-named Works, I/we offer to execute, complete and maintain the whole of the said Works all in conformity with the Tender Documents for the Proposed Fee of Hong Kong Dollars _______, such sums as may be ascertained in accordance with the relevant Conditions of Contract. I/we understood this tender price stated is a fixed lump sum price to perform the requirement set forth in the SOR and shall include all costs of work including purchase, storage, delivery and installation of all tools, equipment and materials etc. No variation claim for the aforesaid items will be allowed which are inclusive in the vendor's scope of work.
- 2.0 I/we undertake if my/our tender is accepted to complete and deliver the Works comprised in the Contract within a period of <u>60</u> days calendar days (including Sundays and general holidays) from the Date for Commencement of the Work.
- 3.0 I/we agree to abide by this Tender for <u>six months</u> from the date fixed for receiving the same. It shall remain binding upon me/us and may be accepted at any time before the expiration of that period.
- 4.0 Unless and until a formal agreement is prepared and executed this tender together with your written acceptance thereof, subject to the provisions of Clause 4 hereof, shall constitute a binding contract between us.
- 5.0 I/we understand that you are not bound to accept the lowest or any tender.
- I/we confirm that I/we am/are a Registered Minor Works Contractors (Company) with valid license as attached, and also having more than 5 years solid work experience of related renovation and A&A projects with relevant previous job & project reference (at least 3 similar projects) attached with this tender submission for HKCHC review and consideration.
- 7.0 I/we understand that the <u>tender must be submitted</u> complete, entire and in the required <u>to HKCHC not later than 3:00 p.m. on 6 June 2024 (Thursday)</u> and the tenders received by HKCHC after the closing time will NOT be accepted.
- l/we understand that for the delivery of Tender, one set of original and one set of copy must be submitted by hand, courier delivery or registered mail. One set should be marked "Original" and the other one set marked "Duplicate". In the event of any discrepancy between the copies, the "Original" one will be taken as the true Tender. The tender is to be submitted in a sealed envelope labeled "Tender for Renovation of Entrance Wall and Gallery Area at G/F for Hong Kong Chu Hai College" and "Private & Confidential" and be addressed to the following:

Hong Kong Chu Hai College Limited Tender Box, 1/F, East Wing, Registrar Office, Hong Kong Chu Hai College, 80 Castle Peak Road, Castle Peak Bay, Tuen Mun, New Territories, Hong Kong

FORM OF TENDER

Signature								
in the capacity of								
duly authorised to sign tende	duly authorised to sign tenders for and on behalf of							
Registered address of firm								
Date	Date							
Signature of witness								
Name in block letters								
Address								
Occupation	Occupation							
Date								
Name of Partners	Residential Address of Partners	Contact Number/Email						

PARTICULAR SPECIFICATION

1 Scope of Contract

1.1 This Contract comprises the provision of all necessary materials and labour to carry out
the works of Renovation Of Entrance Wall & Gallery Area
at Hong Kong Chu Hai College,
all as detailed on the Drawings, General Specifications and this Specification.

2 Site of Works

The site of Works is located at Hong Kong Chu Hai College, 80 Castle Peak Road, Castle Peak Bay, Tuen Mun, N.T. Hong Kong.

3 Terms of Payment

- 3.1 1st Stage: 20% Upon Commencement of work mobilization
- **3.2 2nd Stage:** 30% Upon completion of demolition, plastering, conduit installation, and major base works like furring and flooring with written acceptance by HKCHC and the project designer
- **3.3 3rd Stage:** 45% Upon acquiring practical completion (PC) with major works stated in the tender document completed with written acceptance by HKCHC and the project designer
- **3.4 4th Stage:** 5% Upon completion of 6 months DLP with satisfaction and written acceptance by the Client (HKCHC). Total DLP is 12 months upon the 3rd Stage of practical completion.

4 PRELIMINARIES

Preliminary Items

- 4.1 The Preliminary Items included hereunder apply to the whole of the Works contrained in this Specification and the amount inserted by the Contractor in the Summary of Tender shall be deemed to apply to the whole of the Works carried out under this Contract.
- 4.2 In event of no amount being inserted by the Contractor in respect of Preliminaries, in the Summary of Tender, the value thereof will be deemed to have been included in the cost of the work specified hereinafter following and no separate amount whatsoever will be certified for payment.

5 Contractor to visit the Site

- 5.1 Before tendering, the Contractor should visit the site and satisfy himself as to the accessibility of the side and the extent and character of the operations as no claim due to any neglect in this respect will be entertained.
- 5.2 The Contractor should contact the supervisor of the HKCHC * Mr / Miss / Mrs

 Vincent Lee (Campus Management Office FM Division) on Tel. No. 2972 7389

for permission to visit the site.

6 <u>Programming and Completion of the Work</u>

6.1 The Contractor's particular attention is drawn to the fact that the works to the premises under this Contract must be carried out in co-operation with and agreement of the supervisor of the premises to allow the reasonable operation of the premises and completed within the period stated on the Form of Tender.

Work included in Contract

- 7.1 The Contractor's prices for the items contained in the Contract shall be deemed to include the cost of the incidentals of labour, materials, all cutting and waste, packings, cartage, risk, moving, hoisting and fixing in the required position, scaffolding, plant, ladders, platforms, supervision, profit and all things and matters necessary for the carrying out of and for the timely and satisfactory completion of the entire works contained in the Contract and Specification, such be expressed or not.
- 7.2 All the materials to be used in permanent works described in this Specification shall be taken as new.

8 <u>Lump Sum Tender</u>

- 8.1 The tender shall be "Lump Sum" for the carrying out of the whole of the Works in conformity with the Specifications and Drawings.
- 8.2 Tenderers must include an itemised breakdown in their tenders and a detailed & comprehensive Schedule of Works required and included in the tender.
- 8.3 The Employer will not be liable for any expense incurred by the Contractor in connection with the measurement of variations or the adjustment and settlement of accounts.

9 General Specifications

- 9.1 The Contractor shall be deemed to have examined the following General Specifications applicable to this Contract:
- (a) "General Specification for Building, 2012 Edition" published by the Architectural Services Department;
- (b) "General Specification for Electrical Installatin in Government Buildings the Hong Kong SAR, 2012 Edition "pubblished by the Building Services Branch of the Architectural Services Department.
- 9.2 Allow for any financial obligations imposed by the Preliminaries of the General Specification.
- 9.3 Copies of the General Specifications are obtainable from the Government Publications Centre G/F., Lower Block, Queensway Government Offices, 66 Queensway, Hong Kong.

10 Leave Premises Clean

10 The Contractor shall clean off any dirt and clear any rubbish periodically and on completion of works.

11 Other Restrictions / Rquirements

(To be specified by the HKCHC if applicable) .

12 Material General

- 12 All materials shall be of an approved brand and type fixed and applied strictly, in accordance with the manufacturer's instructions and to the HKCHC satisfaction. Materials shall be submitted to the HKCHC for approval whenever required.
- 12 The Contractor shall submit colour and tint cards and all colour schemes shall be approved by the HKCHC before the work is commenced.
- 12 The Contractor shall also submit a sample board of electrical acessories proposed to be used in the electrical work for the approval of the HKCHC prior to the commencement of the works.

13 Compliance with Specifications

13 Unless otherwise overridden by this Particular Specification or Drawings, all materials and workmanship shall comply with all the relevant sections of the General Specifications as stated in Clause 9.1 above and all the subsequent amendments issued prior to the date of tendering.

SCHEDULE OF MATERIALS AND EQUIPMENT

The tenderer is required to state the type, model and make of all materials / equipment proposed to be used in this Contract. The tender may be considered invalid without submission of such information from the tenderer.

SCHEDULE OF DRAWINGS (if applicable)

20 (List the numbers and titles of all the drawings attached to this document).

DESCRIPTION OF WORKS

21 (Describe in details the works required to be carried out by the Contractor item by item).

Remarks:

The Contractor shall pay attention to the site protection from any injury or theft happened during the works period as the Centre Building shall be in operation as normal and usual.

Hong Kong Chu Hai College in all parts of SOR

Schedule of Rate

Item		Description		TOTAL Amount (HK\$)
	SUMMARY OF TEN	<u>DER</u>		
1.	Schedule No. 1 -	Demolition Work		
2.	Schedule No. 2 -	Preliminaries		
3.	Schedule No. 3 -	Preambles		
4.	Schedule No. 4 -	Partition		
5.	Schedule No. 5 -	Doors		
6.	Schedule No. 6 -	Ceiling & Lighting		
7.	Schedule No. 7 -	Wall Finishes		
8.	Schedule No. 8 -	Floor Finishes		
9.	Schedule No. 9 -	Joineries		
10.	Schedule No. 10 -	Signage		
11.	Schedule No. 11 -	Miscellaneous		
12.	Schedule No. 12 -	E&M Preliminaries		
13.	Schedule No. 13 -	Electrical Works		
14.	Schedule No. 14 -	AV System		I I
		Sub-total	HK\$	
		Total carried to Form of Tender	нк\$	
	Confirmed and Signe	ed by the Main Contractor		
	Committee and Signe	ed by the Main Contractor		
	(with Company's cho	nn)		
		Y)		
	Date			

Item	Description	Qty	Unit	Unit Rate	Amount (HK\$)
	SCHEDULE NO. 1				
	Demolition work				
	Labour to demolish & cast away existing fixture/ finishes to meet new layout (including, but not limited to partition, door, joinery, floor finishes, wall finishes, electrical equipment, etc.)	1	job		
	Additional items requried by the tenderer. Please list below: -				

Item	Description	Qty	Unit	Unit Rate	Amount (HK\$)
	SCHEDULE NO. 2				
	Preliminaries				
Α	To provide CAR insurance (HK\$20,000,000.00)	1	sum		
В	To provide EC, Worker's Compensation	1	sum		
С	To provide site setting out, site marking and coordination for, but not limited for, loose & system furniture & storage units, etc.	1	sum		
D	To provide full-time onsite supervisor	1	sum		
Е	Removal of debris and rubbish during construction period	1	sum		
F	Protection work inside premises	1	sum		
Н	Cleaning work during construction period and deep clean handover	1	sum		
I	To provide shop drawings, sample submission, mock up, and as-built drawing, laminated fire escape plans, light zoning plan and O&M manual within one month of completion	1	sum		
J	To provide weekly report during construction period	1	sum		
K	To attend weekly meeting during construction period	1	sum		
L	To provide any structural/ loading report for submission	1	sum		
N	To provide Site Safety Supervisor in accordance with statutory	1	sum		
0	To provide weekly site safety report during construction period	1	sum		
Р	All works for compliance of Statutory Regulations & Requirements	1	sum		
Q	All works for compliance of Fitout Guidelines and House Rules	1	sum		
R	Testing and Commissioning	1	sum		
S	Visual Mockup on joinery and signage as per required	1	sum		
Т	Making good of all existing finishes & doors	1	sum		
V	To provide deep-cleaning of the site before client move-in	1	sum		
	Additional items requried by the tenderer. Please list below: -	1	sum		

SCHEDULE NO. 3 PREAMBLES

SCHEDULE NO. 3

PREAMBLES

Notes:

- The Tenderer is to study the Specification and Tender Drawings carefully and to visit the site so as to ascertain for himself the exact scope, nature and quality of the Works to be carried out, general site conditions and the requirements or restrictions to be complied therewith.
- The Tenderer is required to enter prices/rates against all items in this Schedule. The Tenderer shall be deemed to have allowed for all other miscellaneous works which are not mentioned in the Specification nor shown on the Drawings but which are indispensably necessary for the satisfactory completion of the Works.
- 3 Unless stated otherwise, all quantities in this Schedule of Quantities and Rates shall be measured nett as fixed in position.
- In respect of Schedule of Quantities and Rates, the quantities unless described as PROVISIONAL as referred to in Clause 7.04 of this Specification Preliminaries provided in the Schedule of Quantities and Rates, while measured with reasonable accuracy, do not form part of the Contract. The Tenderer may adjust the quantities as he deems necessary at the time of submitting the tender. The Contractor is deemed to have verified the given quantities to satisfy himself as to their adequacy and have adjusted the quantities which he deemed necessary in the Schedule of Quantities and Rates and priced accordingly. In any case the quantities in the Schedule of Quantities and Rates are at the sole risk of the Contractor and the Contract Sum will not be adjusted for any errors or omissions in the quantities.

- This is a lump sum fixed price Contract for the completion of the Works as shown on the Drawings and described in the Specifications and includes all components to be provided by the Sub-Contractor for the completion of this Sub-Contract. The Sub-Contract Sum shall not be amended for any reason either due to:
 - (a) any error in quantities or rates inserted by the Sub-Contractor in this Schedule of Quantities and Rates, or
 - (b) the omission by the Sub-Contractor of any particular items required for the completion of this Sub-Contract, or
 - (c) any other errors in the Schedule of Quantities and Rates.

The unit rates inserted herein will be used for the purposes of ascertaining the value of variations and calculating the amounts of interim payments.

- If any items in the Schedule of Quantities and Rates are without a price against the items or with symbols such as "-", "NIL", etc. inserted against the "unit rate" or "amount" columns by the Sub-Contractor, the cost for these items shall deem to be included in other items in the Schedule of Quantities and Rates and hence included in the Sub-Contract Sum.
- 7 The description given for items in the Schedule of Quantities and Rates are not intended as a complete description of the items but merely as an indication for their extent. The complete description shall be as given in the Specification and as shown on the Drawings.
- 8 The tender drawings should be considered as diagrammatic only for the purpose of indicating the design intent such as profiles, configuration, relationship with the structural frames and building interior elements, etc. Any construction detail shown in the tender drawings is for reference only.
- 9 The Sub-Contractor shall be fully responsible for the design and development of details for the Works which can satisfy the design intent shown on the tender drawings and requirements described in the Specification, and completion of the works accordingly.
- 10 The Sub-Contractor shall submit shop drawings and structural calculation for the Works for the Architect's approval.

- The Sub-Contractor shall have referred to the drawings and the Specification to acquaint himself as to the requirements, developed the feasible construction details and priced accordingly. The Sub-Contract Sum will not be adjusted for any omission in the description of any item in the Schedule of Quantities and Rates.
- 12 Only principal items of work are measured, all associated works as required according to the drawings or the Specification or the Sub-Contractor's design shall be deemed to have been included in the rates of the principal items measured.
- 13 Unless otherwise stated and allowed for in the Schedule of Quantities and Rates, the rates shall be deemed to include for :
 - (a) Design and all costs in connection therewith;
 - (b) Labour and all costs in connection therewith;
 - (c) Materials, goods and all costs in connection therewith;
 - (d) Fitting and fixing materials and goods in position;
 - (e) Use of tools and plant and all costs in connection therewith;
 - (f) All cutting and waste;
 - (g) Establishment charges, overhead charges and profit;
 - (h) Preparing detailed design drawings where necessary and all working drawings for the fabrication and installation of the Works;
 - (i) Consumables and services and all costs in connection therewith;
 - (j) Executing the work in large or small quantities;
 - (k) All planning/programming of work, liaison with other contractors and/or trades;
 - (1) All protection of materials for incorporation into the work, protection of the work and cleaning up on completion;
 - (m) All associated work required as part of normal good trade practice whether or not specifically mentioned on the drawings, in the Specification or the Schedule of Quantities and Rates; and
 - (n) All other expenses incurred in complying with the requirements of this Sub-Contract.

14 The quantities described as PROVISIONAL in the Schedule of Quantities and Rates are subject to remeasurement upon completion of the works. The Sub-Contract Sum shall be adjusted accordingly.

"Items" within sections of the Provisional Quantities are provisional and the sums inserted against the various "Items" will be included in the remeasurement upon completion of the works only when instructed by the Architect. If the work described in an "Item" is not required, the relevant sum will be omitted from the remeasurement.

The works which are the subject of the Provisional Quantities will be measured as constructed and paid for at the rates contained in the Schedule of Quantities and Rates.

The Provisional Quantities are estimates only and no responsibility can be taken for their accuracy. No adjustment will be made to the contract Sub-Contract rates used for pricing the remeasured quantities nor extension allowed to the contract period should the final quantities differ from the original Provisional Quantities.

- Where prime cost (P.C.) rates are included in the descriptions of items in the Schedule of Quantities and Rates they are either for the material cost of items or are for the supply and installation or application of items.
- P.C. rates for materials are for the supply of materials to site only and the Contractor shall allow in addition for taking delivery from the supplier at street level, unloading or assisting in unloading, storing, distributing to required positions, returning packing cases etc. to the supplier (including paying transportation charges and obtaining credits for the packing cases etc), all waste, fixing, all ancillary materials required for fixing such as mortar for bedding and jointing and all other similar items of a like nature, for any finance charges arising from the terms of payment required by the supplier and for the Contractor's allowance for profit. As for P.C. rates included in the descriptions for the supply and installation or supply and application of items such as specialist suspended ceilings or finishes, the Contractor shall include his allowance for any finance charges arising from the terms of payment required by the specialist and his allowance for profit and attendance on the specialists carrying out the works. The attendance shall be equal to that provided for Specialist Contract works detailed in the Attendance on Specialist Contractors Specification -Provisional Sums.

- The Contract rate will be adjusted by the nett difference between the prime cost rate and the actual price and will be applied to the nett quantity of the items fixed, installed or applied in position.
- 18 The P.C. rate for the supply and delivery of tiles includes for factory finishing and cutting to the general sizes required. All other cutting including cutting for narrow widths, equal margins and angles and polishing exposed edges and slightly rounding arises shall be allowed for in the fixing costs.
- 19 The P.C. rates for the supply and delivery of all enumerated items includes for all labour in cutting and finishing to the final shape of the item required.

Item	Description	Qty	Unit	Unit Rate	Amount (HK\$)
	SCHEDULE NO. 4				
	Partition Work Supply and installation of partitions including all necessary metal stud, supporting frame and fixing accessories				
4.01	Gypsum board w/ plywood furring c/w GI metal stud from F.F.L. to F.C.L.		m2		
4.02	Labour, material and tool to allow opening for M&E and ELV work and sealing up		sum		
4.03	Labour, material and tool to allow plywood backing for additional layer of plywood backing to the drywall area where proprietary or build in exhibition wall will be installed		m2		
4.04	Labour, material and tool to allow all wall opening / access panels related to M&E services and making good work with acoustic treatment		sum		
4.05	Labour, material and tool to make good on existing wall partition wall upon the demolition works		sum		
	Additional items requried by the tenderer. Please list below: -				

Item	Description	Qty	Unit	Unit Rate	Amount (HK\$)
	SCHEDULE NO. 5				
	Door Work; refer to door type schedule & ironmongery schedule supply & installation of door including ironmongery				
Α	Conceal Access Door		no		
	Additional items requried by the tenderer. Please list below: -				

Item	Description	Qty	Unit	Unit Rate	Amount (HK\$)
	SCHEDULE NO. 6				
	Ceiling Work				
6.01	Make good on existing ceiling panels		sum		
6.02	Supply and install 3M sticker on existing ceiling panels		m2		
6.03	RB01; Electric Roller blind		m2		
6.04	RB02; Electric Roller blind		m2		
6.05	Provision of ceiling opening for all access panel, MEP and ELV fittings		sum		
	Additional items requried by the tenderer. Please list below: -		sum		

Description	Qty	Unit	Unit Rate	Amount (HK\$)
SCHEDULE NO. 7				
Wall Finishes Supply and Installation of finishes including all necessary plastering, base coat and plywood backing				
Labour, material and tool to make good on base plastering		sum		
PT-01		m2		
Labour, material and tool to allow opening and touchup for M&E, light fittings and ELV work		sum		
Additional items requried by the tenderer. Please list below: -		sum		
	Wall Finishes Supply and Installation of finishes including all necessary plastering, base coat and plywood backing Labour, material and tool to make good on base plastering PT-01 Labour, material and tool to allow opening and touchup for M&E, light fittings and ELV work Additional items requried by the tenderer.	Wall Finishes Supply and Installation of finishes including all necessary plastering, base coat and plywood backing Labour, material and tool to make good on base plastering PT-01 Labour, material and tool to allow opening and touchup for M&E, light fittings and ELV work Additional items requried by the tenderer.	Wall Finishes Supply and Installation of finishes including all necessary plastering, base coat and plywood backing Labour, material and tool to make good on base plastering PT-01 Labour, material and tool to allow opening and touchup for M&E, light fittings and ELV work Additional items required by the tenderer.	Wall Finishes Supply and Installation of finishes including all necessary plastering, base coat and plywood backing Labour, material and tool to make good on base plastering PT-01 Labour, material and tool to allow opening and touchup for M&E, light fittings and ELV work Additional items required by the tenderer.

Item	Description	Qty	Unit	Unit Rate	Amount (HK\$)
	SCHEDULE NO. 8				
	Floor Finishes Supply and installation of floor finishes including all necessary backing, touchup and leveling to form a smooth surface to receive floor finishes				
8.01	Labour, material and tool to repair & make good on the raise floor panels		sum		
8.02	Labour, material and tool to install new raise floor panels and pedestials to replace with the broken		m2		
8.03	Labour, material and tool to adjust the level on the raise floor system to receive new floor finishes		m2		
8.04	CP01; Carpet tiles		m2		
8.05	Supply and installation of 3mm stainless steel trim in between different floor finishes		lm		
	Additional items requried by the tenderer. Please list below: -				
	I lease list below.				

ltem	Description	Qty	Unit	Unit Rate	Amount (HK\$)
	SCHEDULE NO. 9				
	Joineries				
	Design to approval, supply and installation of built-in-furniture including supporting frame, self-closing drawers and cabinet doors, LED light track, ironmongeries, adjustable shelves, all ncessary accessories and forming openings for MEP connections & sanitaryware. The contractor shall be required to submit material samples for PM's or Interior Designer's approval before				
9.01	Info Island		No.		
9.02	LED Screen Storage Cabinet		No.		
9.03	Integrated Exhibition Wall		No.		
9.04	Modular Display Shelf		No.		
9.05	Display Shelf		No.		
	Additional items requried by the tenderer.				
	Please list below: -				

em	Description	Qty	Unit	Unit Rate	Amount (HK\$)
SCHEDULE NO	<u>D. 10</u>				
Signage Supply and Ins supply and plyv	tallation of signage including all necessary base coat, power wood backing if necessary				
0.1 GA - Faculties	D		no		
0.2 GB - Directory	D		no		
0.3 GC - College E	mblem		no		
0.4 GD - Gallery ID			no		
0.5 GE - Present Z	one ID		no		
),6 GF - Present Z	one Introduction		no		
0.7 GG - Past Zone	e ID		no		
0.8 GH - Past Zone	e Introduction		no		
0.9 GI - Façade Gr	aphic		no		
Additional items Please list belo	s requried by the tenderer. w: -				

Item	Description	Qty	Unit	Unit Rate	Amount (HK\$)
	SCHEDULE NO. 11				
	<u>Miscellaneous</u>				
Α	Labour, material and tool to remove existing AV server and speaker with well protection and relocate to a designed location		sum		
В	Labour, material and tool to make good on eixsting rain pipe		sum		
С	Labour, material and tool to make good and deep clean on existing entrance carpet		sum		
D	Labour, material and tool to relocate on existing equipment & factilties & system c/w conduit and wiring such as Fire Services, WiFi AP, light fittings, CCTV, Speakers, etc. in order to suit for the required design and renovation works		sum		
	Additional items requried by the tenderer. Please list below: -				

ITEM		DESCRIPTION		Unit rate (HK\$)	QTY	Amount (HK\$)
A		and General Requirement (to comply with scope, details refer to Section B0 for scope of works)				
	1	Liaison with and application to Building Management, Utility Companies, Government Authorities, including provision of all documents and fees / application & submission fee to fulfil the statutory requirements.	Sum			
	2	Liaison and coordinate with relevant parties, such as other designated contractor, nominated supplier, client's direct contractor, other trade contractors and the project design or management team for exact requirements and setting out of respective installation	Sum			
	3	Provide all necessary submission for approval and obtain the completion certificates in due course to meet with the Local Authorities requirement	Sum			
	4	Provision of maintenance and emergency call-out service at all time during the Defects Liability Period. Provide the guarantee for all equipment as specified.	Sum			
	5	Training of the Employer's staff in operating and regular maintenance of the installation.	Sum			
	6	Provision of spare parts according to the requirement of the specification	Sum			
	7	Provision of material submission, sample submission, shop drawing submission, mock-up installation, method statment, testing procedure / method statment, as-fitted drawings, O&M manual, T&C report, working drawings, CD-ROM containing as-fitted drawings and O&M manual and statutory submissions/forms as required by the work and the local authorities.	Sum			
	8	Attend all meeting, coordination, testing and inspection which including the inspection of utilities and building management required by the Client, Architect/Interior Designer ,Engineer, Building Management Office and Authorities.	Sum			
	9	Provision of complete painting, labelling, operation instruction, on-site operation drawings of all installation.	Sum			
	10	Provision of the safe demolition and disposal (to assigned location) of all redundant existing services installations. Provision of temporary and permanent diversion of existing services passing through the work	Sum			
	11	Provision of commissioning and testing, including both factory test if required, and on-site test for individual installation and integrated system test of all system with building systems.	Sum			
	12	Provision of equipment and material guarantees as detailed in this specification	Sum			
	13	Provision of all necessary information, setting out, detail, shop drawings (soft copy in auto CAD format),	Sum			
	14	Preparation and submission of calculation, system detail design, shop drawings, working method statement before commencement of works.	Sum			
	15	Arrange necessary protection of existing building structure / installation and isolate any existing building	Sum			
	16	Provision of Builder's work drawings to the Building management and the Project Supervision team for approval.	Sum			
	17	Provide the required builder's works for the M&E installation	Sum			
	18	Assign the full time experienced M&E project manger and on-site full time experienced M&E project engineer / BS coordinator for this project	Sum			
	19	Demolish, modification, relocation and protection of the existing M&E installation to suit new office M&E installation, and fitting out requirement	Sum			
	20	Engage the building nominated M&E contractors / attendance charge to carry out the works scope / type as required by Landlord fitting out guideline	Sum			

ITEM	DESCRIPTION			Unit rate (HK\$)	QTY	Amount (HK\$)
	0.4		Unit	Officiale (HK\$)	α	πιποαπε (ππφ)
	21	Whole project coordination to complete all M&E and fitting out installation to suit the design requirement and site condition	Sum			
	22	Contractor are responsible for preparation of the Government Departments / Authorities submission	Sum			
	23	Relocation, modification, dismantle & removal of existing base building M&E installation as necessary to suit the new installation as shown on drawings and site condition	Sum			
	24	Provide the temporary and sufficient power, lighting, ventilation, water supply, fire protection, etc. for construction and system commissioning	Sum			
	25	Provide detail combined services drawing (CSD) for well coordinated installation to suit the ceiling installation, achieve the required false ceiling height requirement, for future maintenance and good acoustic performance.	Sum			
	26	Allowance for project team organization including the experienced full time M&E project manager, full time onsite M&E project engineer / full time on-site Building Services coordinator and necessary resources as	Sum			
	27	Preparation and coordination for complete M&E system Integrated System / Performance Verification test as required testing items . The necessary coordination with BMO for building system side, and other trade contractors for the test. The necessary temporary provision shall be included for the complete test.	Sum			
	28	Conduct detail site survey / provision verification when site possession and submit the survey report with defect	Sum			
	29	Necessary provision as required to suit site condition for complete system installation	Sum			
	30	Necessary allowance for coordinate, interface, temporary provision, relevant installation with other trade contractor, including IT cabling contractor, security contractor, AV contractor, and other client direct contractors for complete installation and project works.	Sum			
	31	Provision for phase works and temporary provision for phasing completion / handover / operation. Protection for existing installation / completed works for phasing works	Sum			

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ITEM	DESCRIPTION		Unit	Unit rate (HK\$)	QTY	Amount (HK\$)
A. Mai	n & Su	bmain Distribution				
1	Fuses	witch / MCCB c/w all necessary accessories				
	a.	Fusewitch / Isolator				
		Modify on the existing to receive new power provision if necessary	sum			
	b.	MCCB				
		Modify on the existing to receive new power provision if necessary	sum			
4	Sub-m	nain Distribution Board				
	а	MCCB Board				
		Modify on the existing to receive new power provision if necessary	sum			
	b	MCCB				
		Modify on the existing to receive new power provision if necessary	sum			
	С	MCB Board				
		Modify on the existing to receive new power provision if necessary	sum			

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ITEM	DESCRIPTION	Unit	Unit rate (HK\$)	QTY	Amount (HK\$)
5	Cable (including terminating gland & lug)				
	a. PVC insulated Copper Cable				
	25mm sq 1/C	m			
	16mm sq 1/C	m			
	10mm sq 1/C	m			
	6mm sq 1/C	m			
	4mm sq 1/C	m			
	2.5mm sq 1/C	m			
	1.5mm sq 1/C	m			
	b. XLPE/PVC insulated copper cable				
	150mm sq 1/C	m			
	120mm sq 1/C	m			
	95mm sq 1/C	m			
	70mm sq 1/C	m			
	50mm sq 1/C	m			
	35mm sq 1/C	m			
	25mm sq 1/C	m			
	16mm sq 1/C	m			
	10mm sq 1/C	m			
D 0.1					
	G.I. trunking with hangers, including fittings				
1					
	150x100	m			
	200x100	m			
	100x100	m			
	150x100 150x35	m			
	100 X (100+100+100) 3C	m m			
	100 x (100+100+100) 3C	1111			
2	G.I. Cable Tray				
	- 450mm(W)	m			
	- 300mm(W)	m			
	- 200mm(W)	m			
C. Fina	al circuit installation				
	Lighting Conduits Wiring Point c/w G.I. conduits, conduit				
1	box, flexible conduit, 1/c pvc cable and conduit / cable				
'	accessories for				
	(chiseling works on floor /wall finsihes by builder)				
	LT01 Spot Light	no.			
	LT02 Spot Light	no.			
	LT03 track light	no.			
	LT03a track	m			
	LT04 Wall Washer	no.			
	LT05 Down Light	no.			
	LT06 LED strip	m			
	EXIT sign	no.			
	Directional light	no.			
	Emergency battery pack for light fittings (3 hours c/w FS 251	no.			
1			1		

Hong Kong Chu Hai College Renovation of Entrance Wall & Gallery Area at G/F

ITEM	DESCRIPTION	Unit	Unit rate (HK\$)	QTY	Amount (HK\$)
2	Small Power Conduits Wiring Point c/w G.I. conduits, conduit box, flexible conduit, 1/c pvc cable and conduit / cable accessories and Wiring Accessories for (chiseling works on floor /wall finsihes by builder)				
	13A, 3-pin single socket outlet (plastic plate)	no.			
	13A, 3-pin twin socket outlet (plastic plate)	no.			
	13A, 3-pin single socket outlet (plastic plate) with USB charger outlet				
	13A, 3-pin twin socket outlet (plastic plate) with USB charger outlet	no.			
	13A switched spur unit with fuse (plastic plate)	no.			
	13A switched spur unit with fuse (metal plate for return air plenum area)	no.			
	20A DP cooker switch, c/w pilot light	no.			
	32A DP cooker switch, c/w pilot light	no.			
	32A 3pin commando socket & plug	no.			
	16A pin commando socket & plug	no.			
3	Data / ELV Conduits Point c/w G.I. conduits, conduit box, flexible conduit, conduit accessories, outlet plate, including supply and install wiring, wiring termination for (chiseling works on floor /wall finsihes by builder)				
	 IT Data point (from G/F server room to AV Rack) HDMI & AV point from AV Rack to TVs / Display 	no.			
	- ITIDIVIT & AV POLITE HOTT AV KACK TO TVS / DISPIRY	no.			
				<u> </u>	

		l			
ITEM	DESCRIPTION	Unit	Unit rate (HK\$)	QTY	Amount (HK\$)
D. Ligl	hting installation				
1	Supply & Installation of lighting fixtures including lamps and				
!	control gears				
	LT01 Spot Light	no.			
	LT02 Spot Light	no.			
	LT03 track light	no.			
	LT03a track	m			
	LT04 Wall Washer	no.			
	LT05 Down Light	no.			
	LT06 LED strip	m			
	EXIT sign	no.			
	Directional light	no.			
	Emergency battery pack for light fittings (3 hours) c/w FS 251	no.			
F. Ligh	nting Control System				
1	Light Switch	no.			
2	To modify and match with existing lighting system	sum			
_					
F. Eart	thing and Equipotential bonding				
	a Electrical main earthing terminal	no			
	b Clean earth main terminal	no			
	c. Equipotential bonding per statutory requirement	lot			
G. Ger	l l neral & Other items				
1	Working drawing, drawing for authorities submission, engineering support and attendance	lot			
2	Maintenance & attendance of emergency call During DLP	lot			
3	Testing and commissioning	lot			
4	As-built drawing and O&M manual	lot			
5	Work completion certificate for equipment such fire damper etc				
6	Proivde lux report for design approval				
	Additional items requried by the tenderer.				
	Please list below: -				
			,	Total car	ried to Summary

Item	Description	Quantity	Unit	Rate	Amount
	SCHEDULE NO. 14 - AV System				
А	Supply and Install AV system as per the specification Additional items requried by the tenderer. Please list below: -		Sum		
		Total Car	ried to	Summary	

Hong Kong Chu Hai College in all parts of SOR

Tender Drawing



TENDER DOCUMENT ISSUED FOR: TENDER DRAWING ISSUED BY: NOBO DESIGN DATE: 22 APR 2024 APPROVAL: DATE:

PROJECT MANAGER	CONTRACTOR	DESIGN ARCHITECT	CONSULTANT	CONSULTANT
		NO <i>BO</i>		
-	-	No Boundary Design noboundarydesign.com Email: info@noboundarydesign.com	-	-

PREPARED BY



	DRAWING	REGISTER	Issue Dat	e / Revision								
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	0100	Drawing Register	А									
Plans	1000	Demolitions Plan	А									
	1100	Layout Plan	А									
	1200	Setting Out Plan	А									
	1300	Floor Finishes Plan	А									
	1400	Reflected Ceiling Plan	А									
	1500	Electrical Plan	А									
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Elevations	2000	Elevations - Past Zone	A	В								
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	2300	Elevations - Info Island	А									
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chitectural	3000	Typical Floor Details	А									
Details												
Joinery	4000	FX-01 Modular Display Shelf	А									
Details	4001	FX-01 Modular Display Shelf	A									
	4002	FX-01 Modular Display Shelf	A									
		EX-02-Integrated Exhibition Wall										
(4100	FX-03 Integrated Exhibition Wall (LED Wall)	A	B								
		FX-03 Integrated Exhibition Wall (LED Wall)	 	<u> </u>)							
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	4300	FX-04 Integrated Exhibition Wall (TV)	A	B 人人人人)							
	4301	FX-04 Integrated Exhibition Wall (TV)										
	4700	FX-08 Display Shelf	A									
	4800	FX-09 Display Shelf	A									
	4900	FX-10 Info Island (LED Wall)	Α									
	4901	FX-10 Info Island (LED Wall)	A							-		
	4902	FX-10 Info Island (LED Wall)	A A									
			+									
	4902	FX-10 Info Island (LED Wall)	А									
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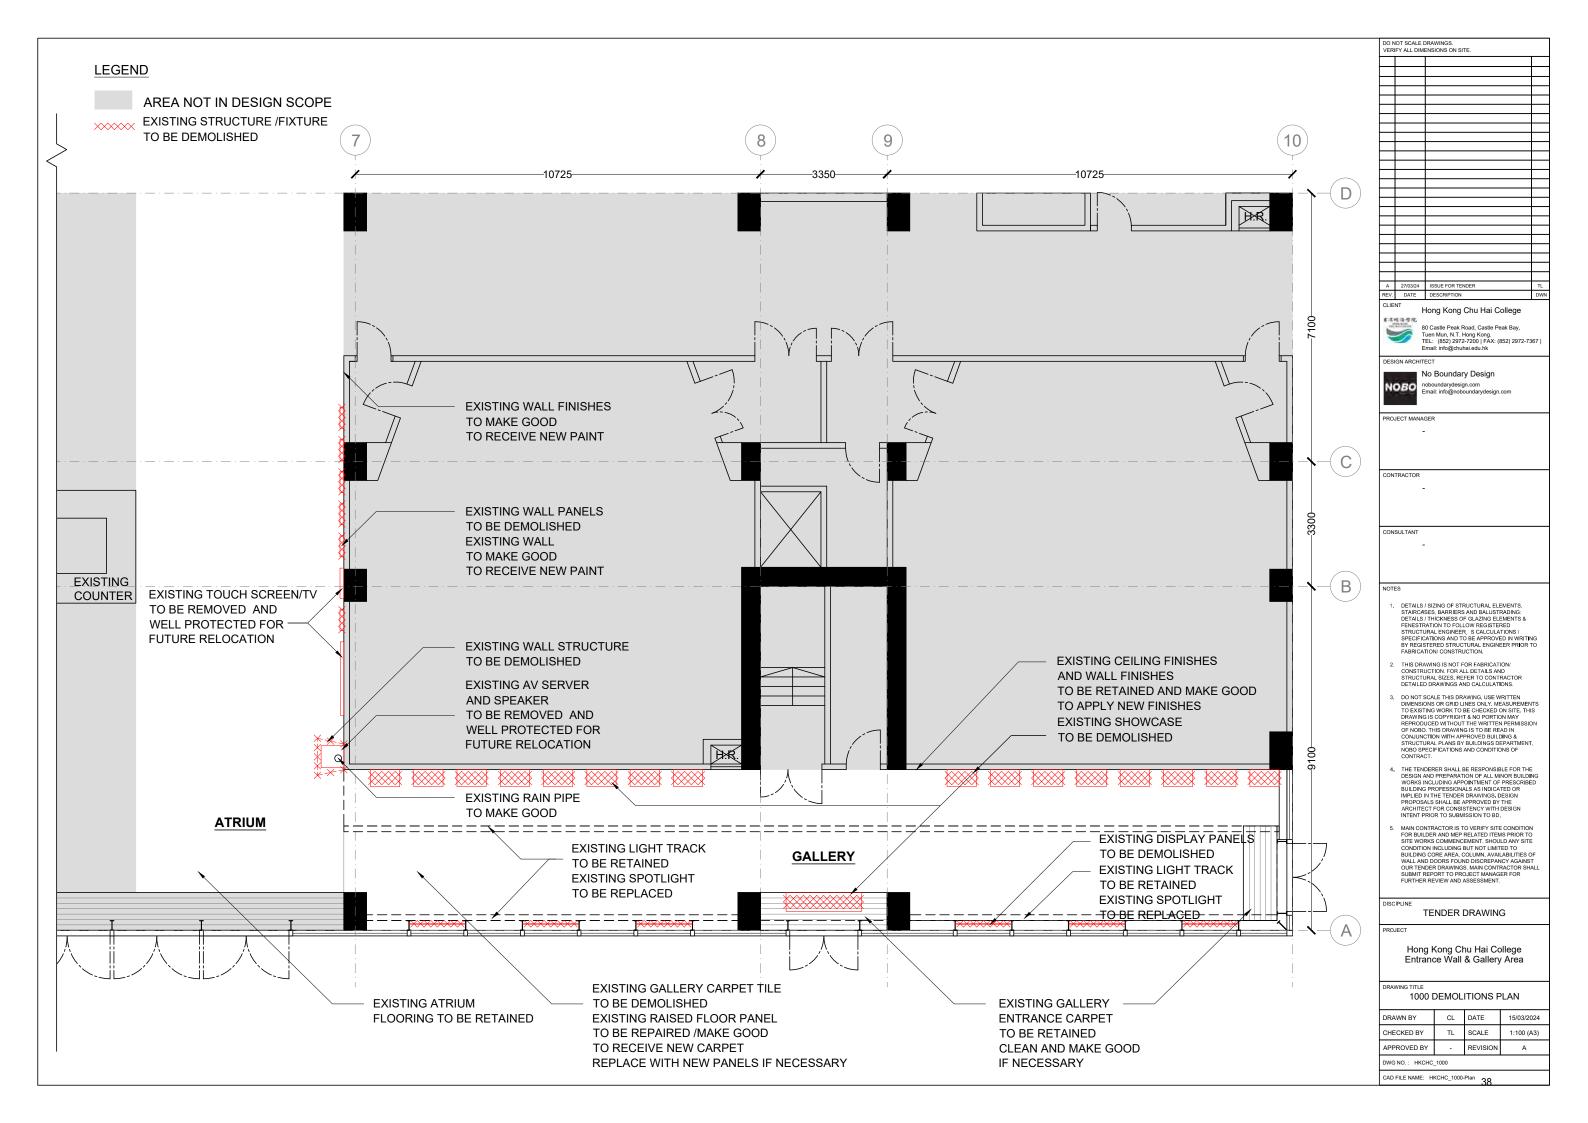
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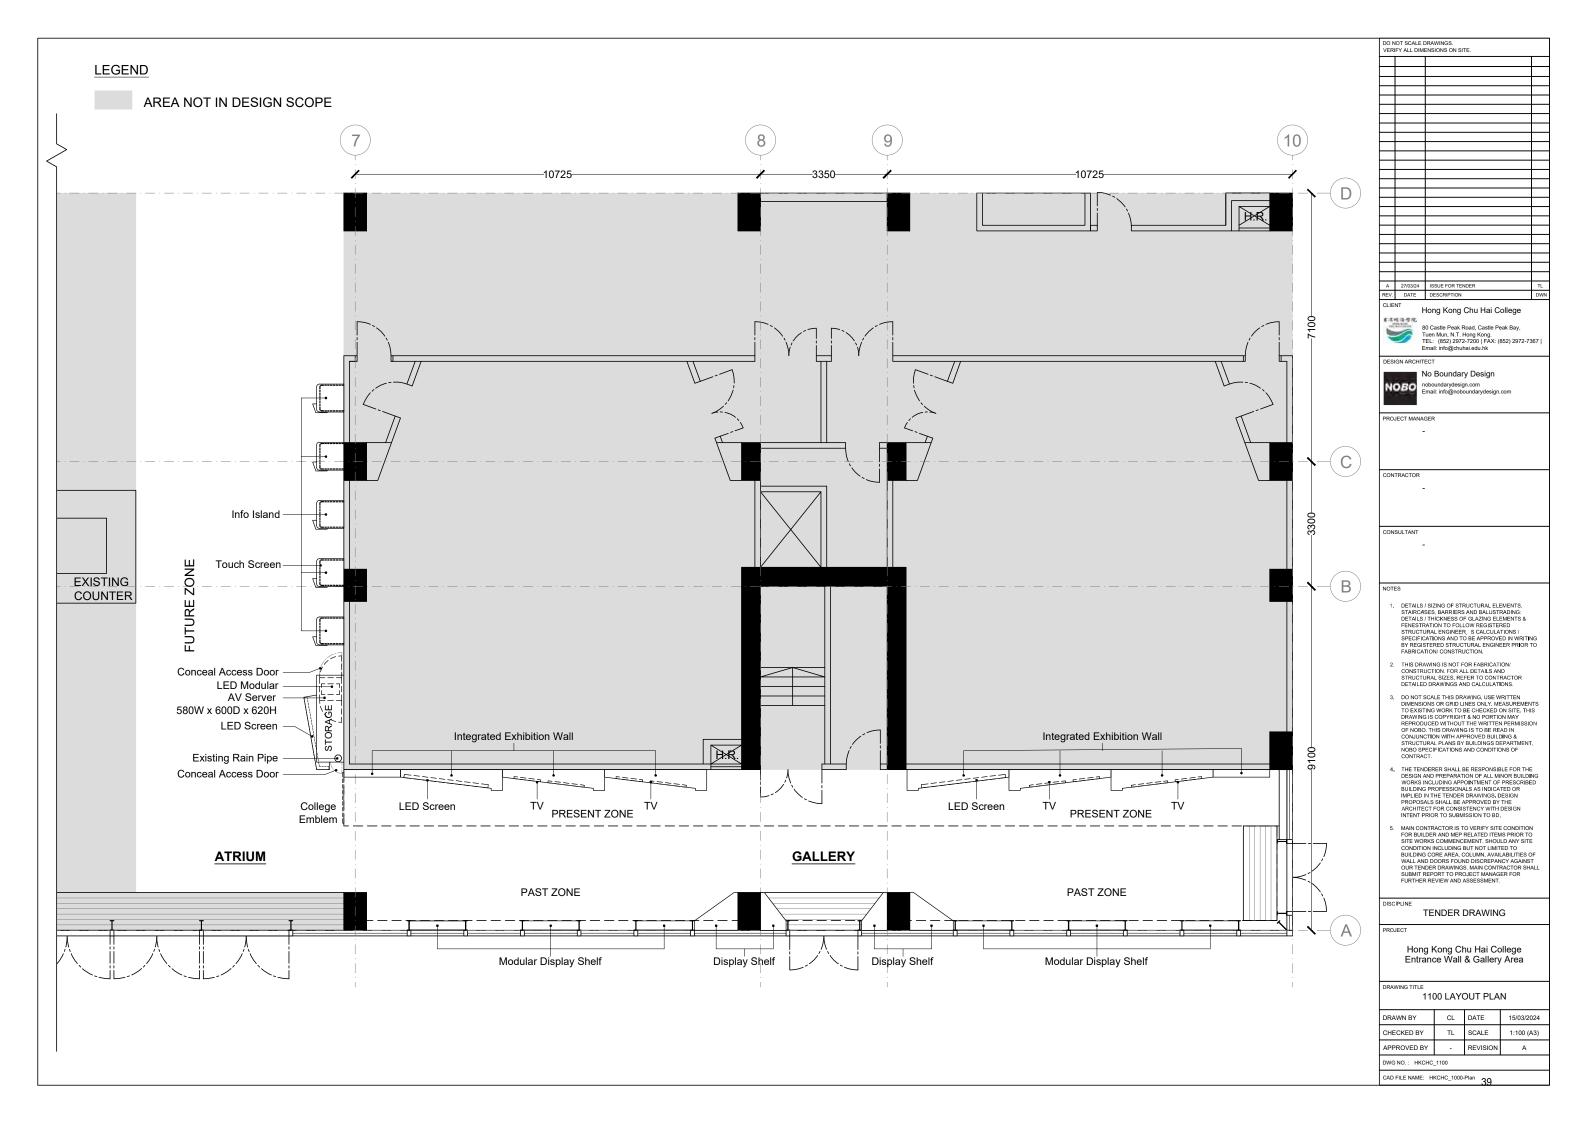
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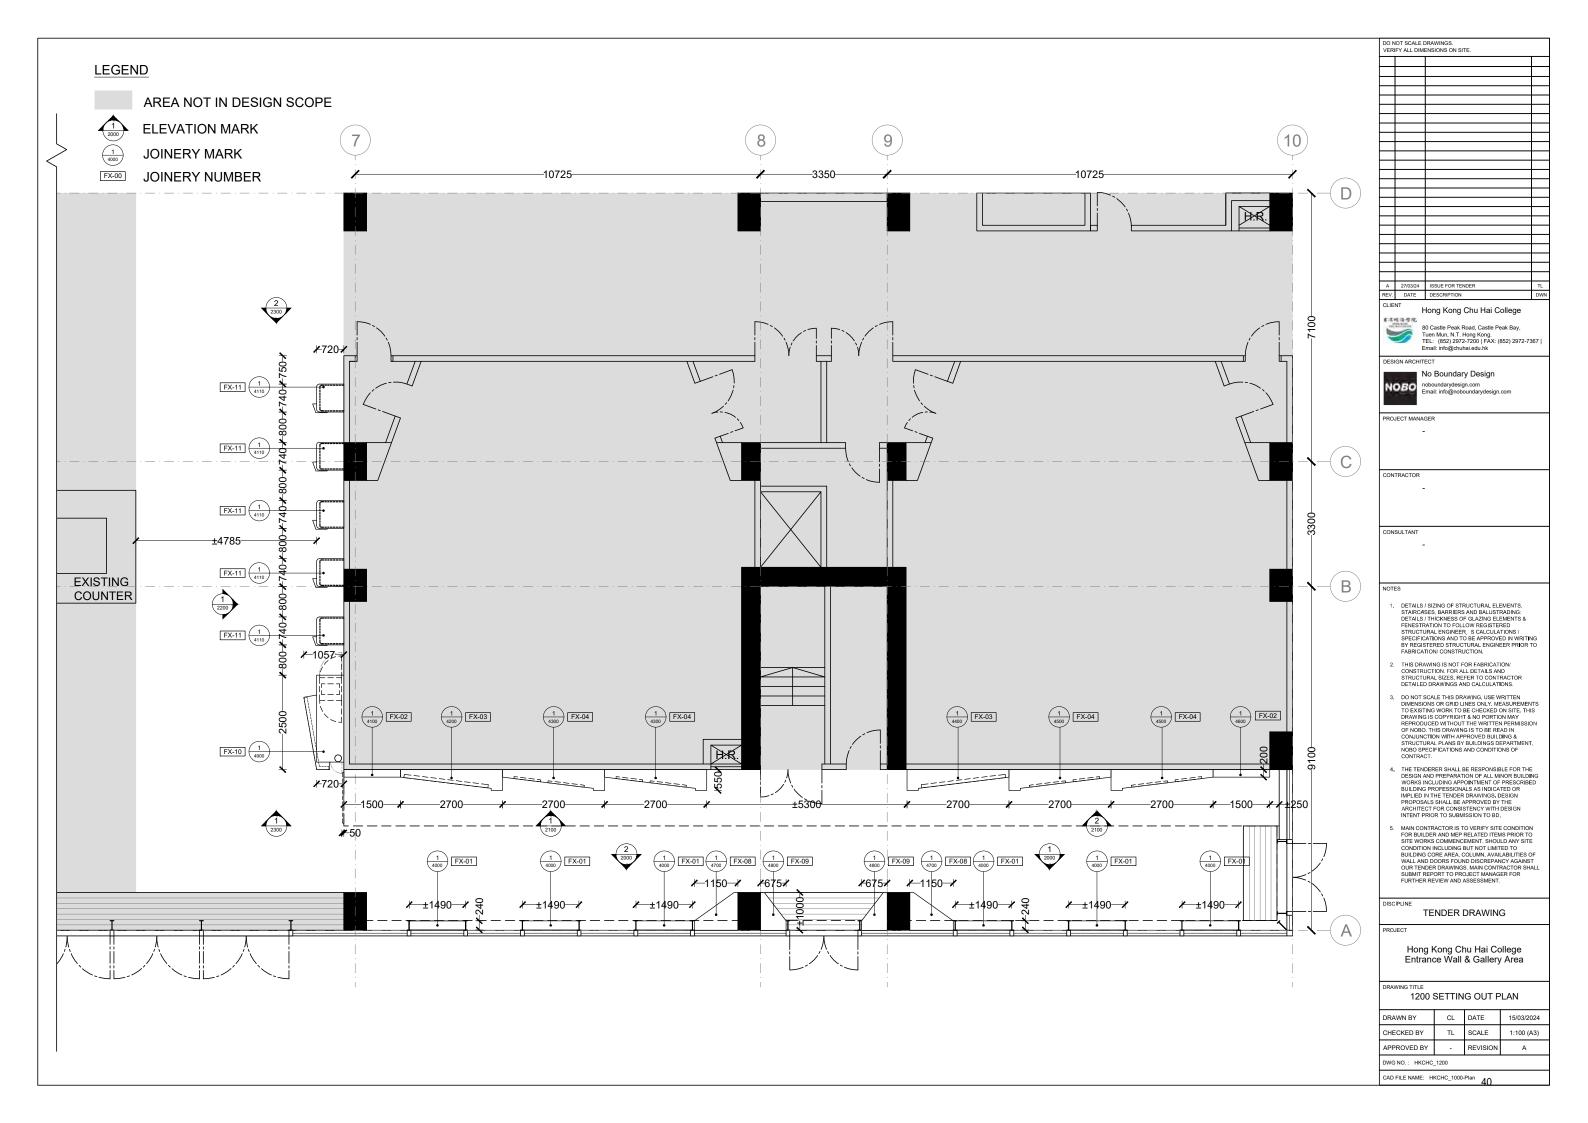
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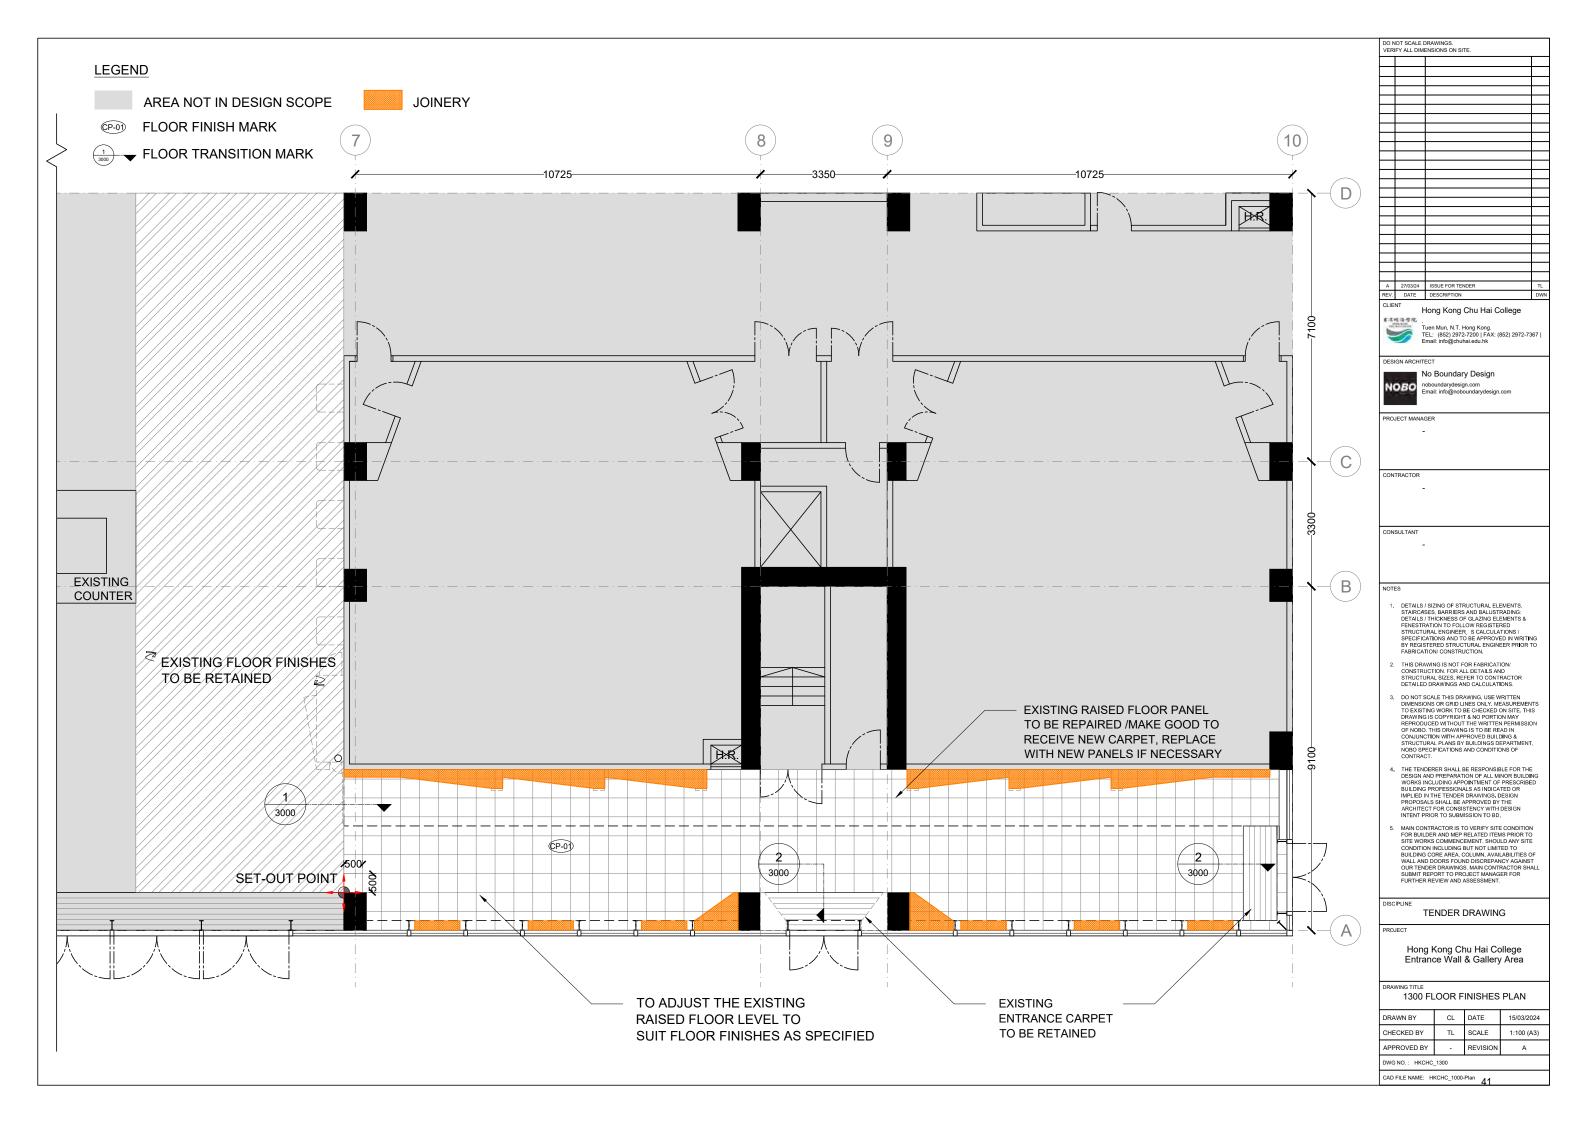
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CHECKED BY	TL	SCALE	N/A
APPROVED BY	-	REVISION	В
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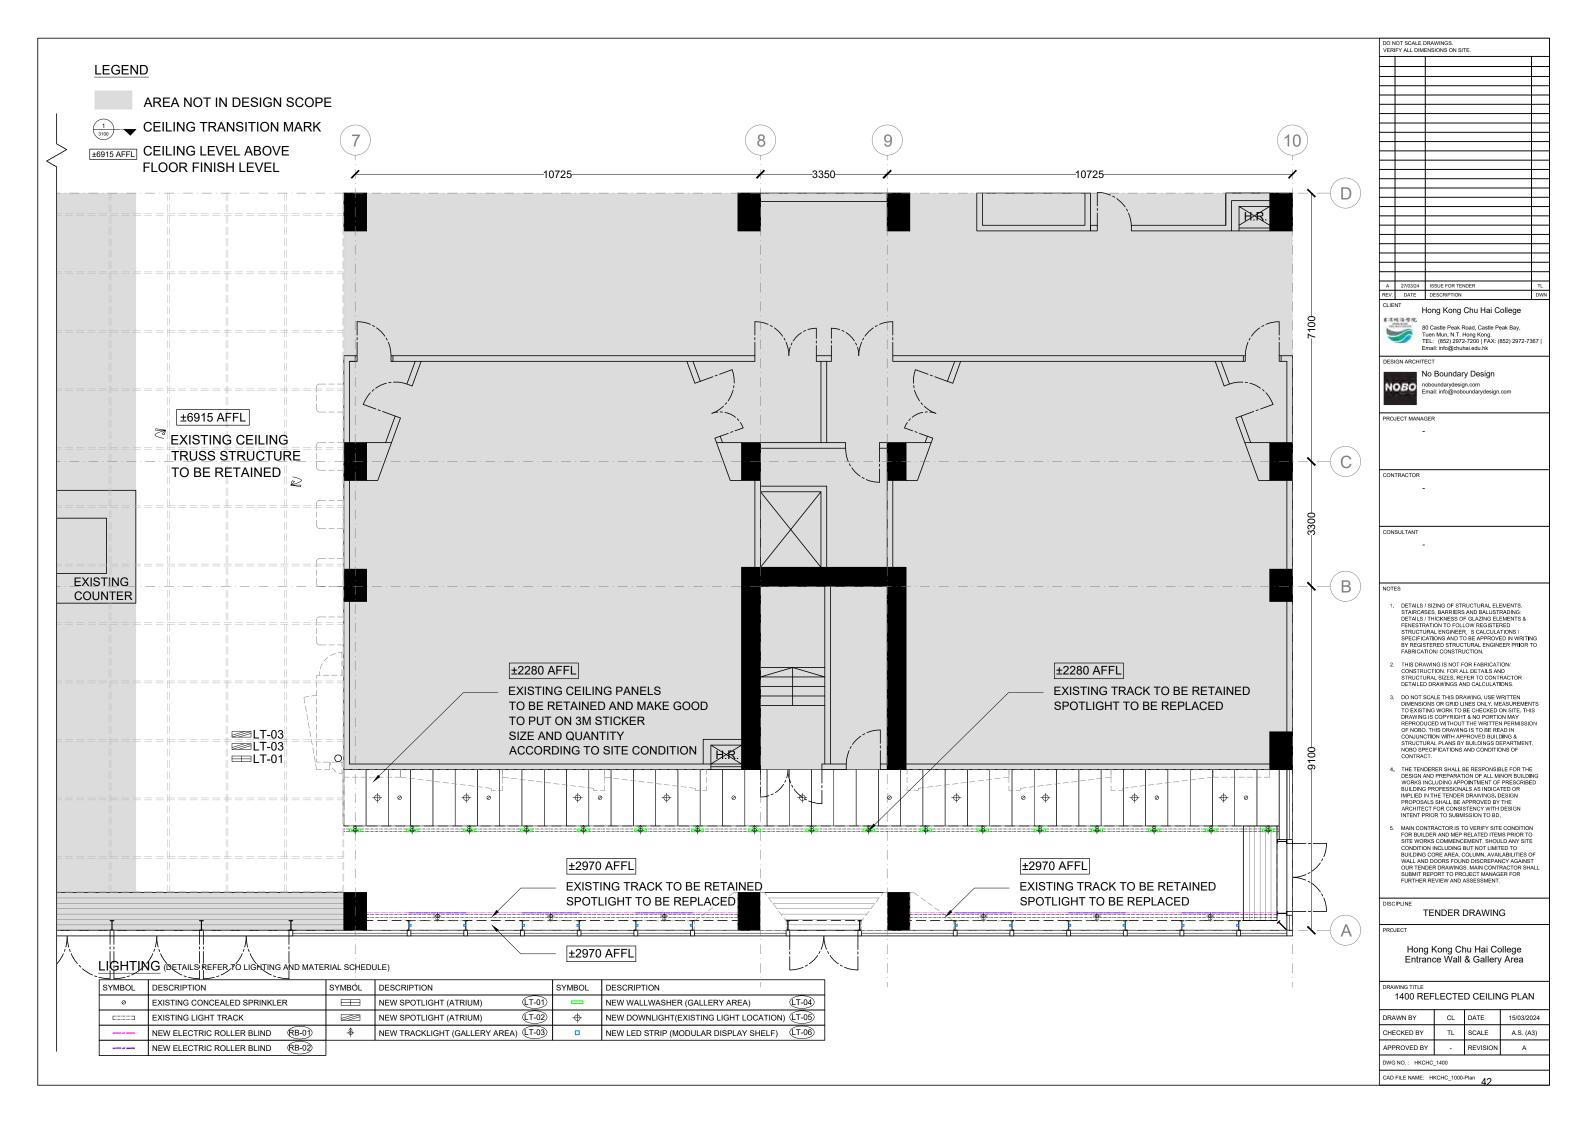
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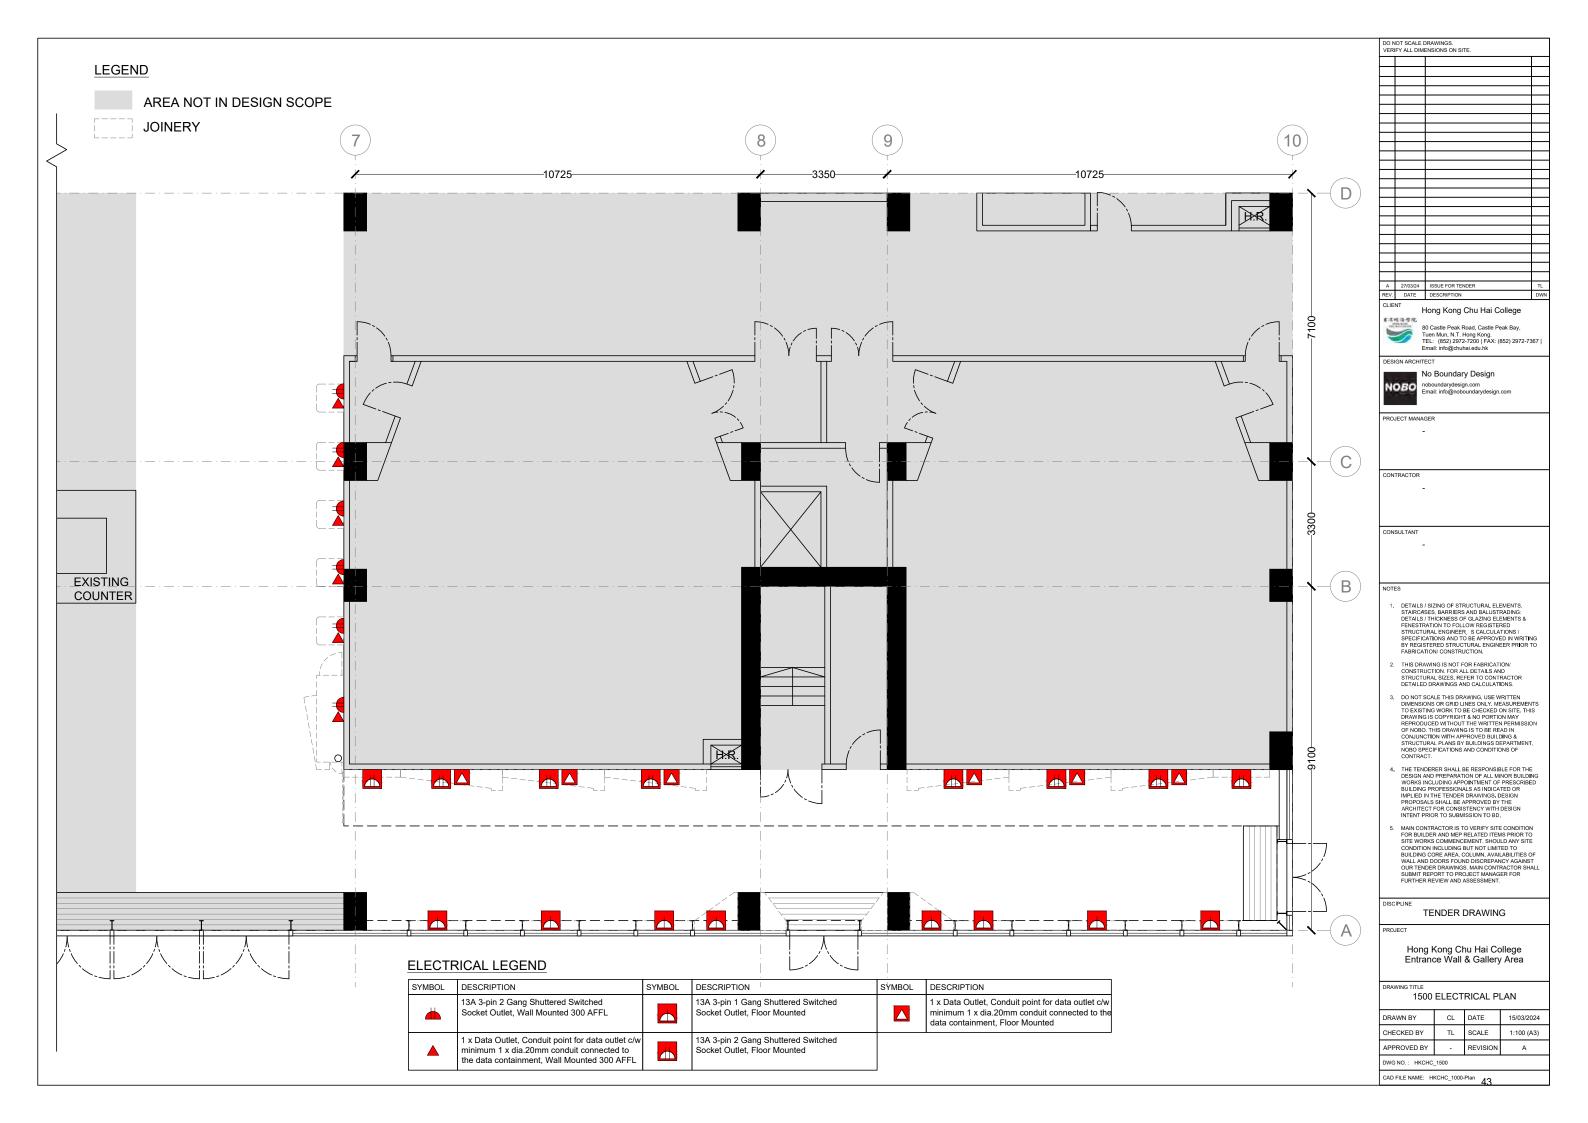

















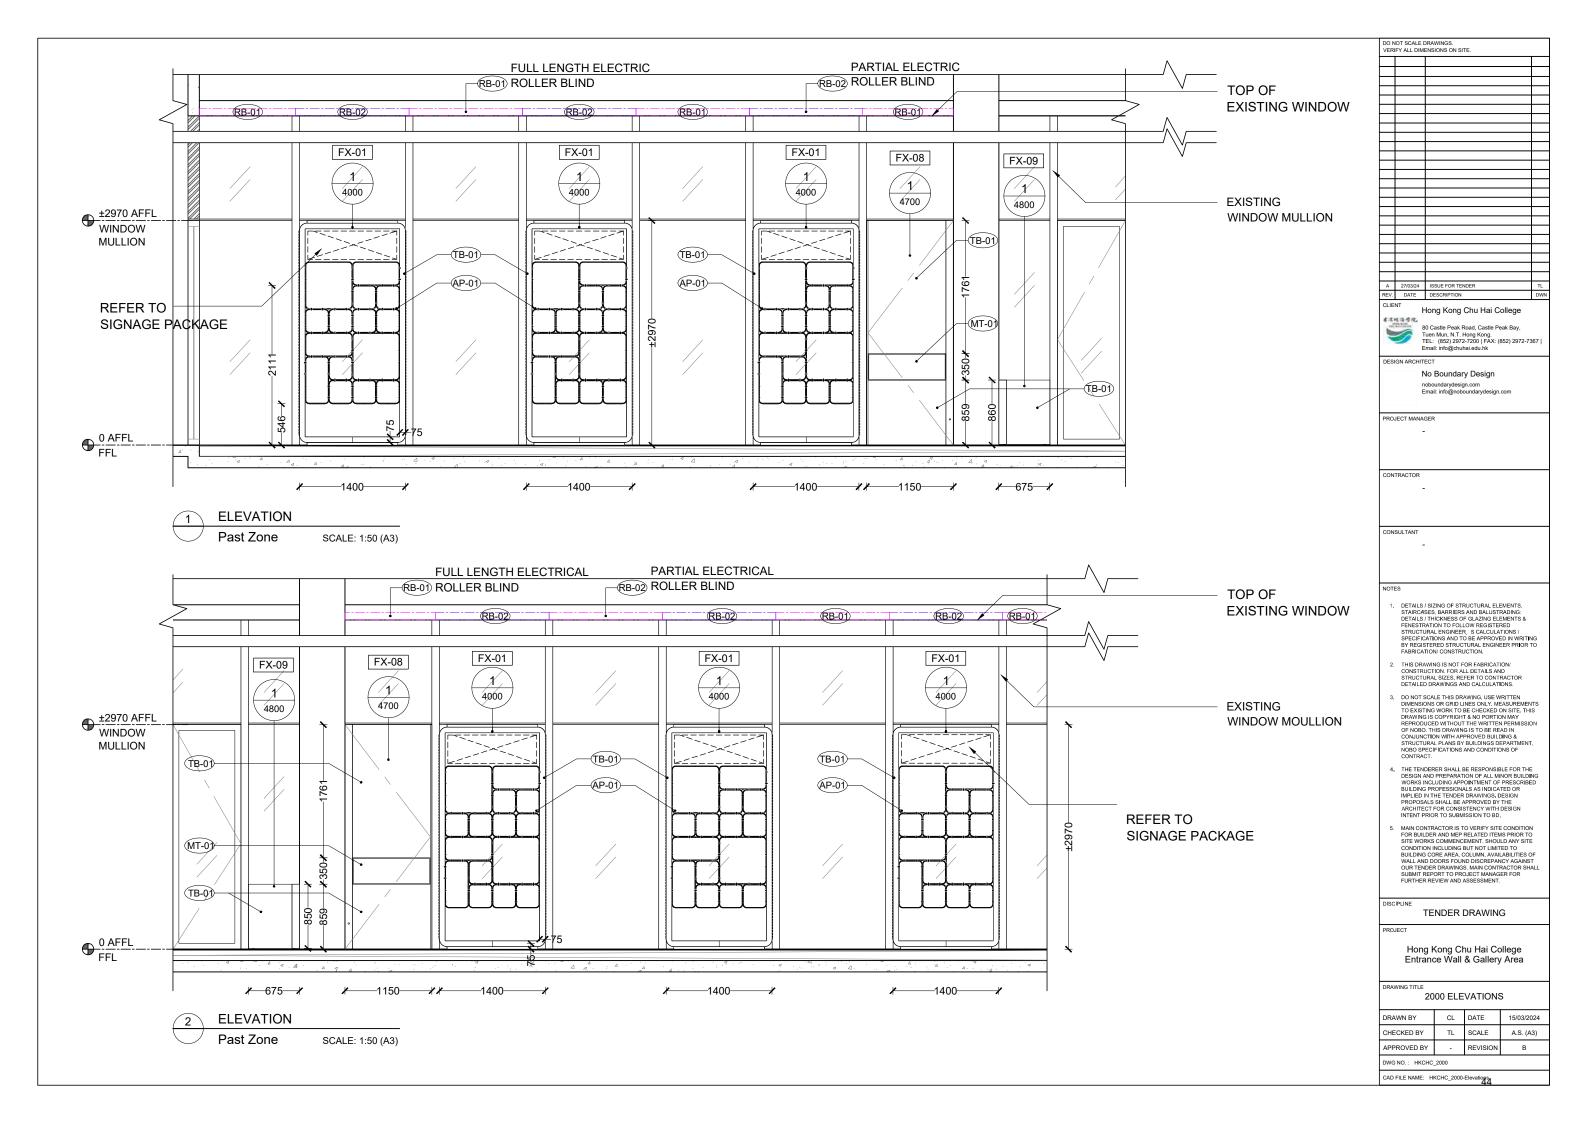


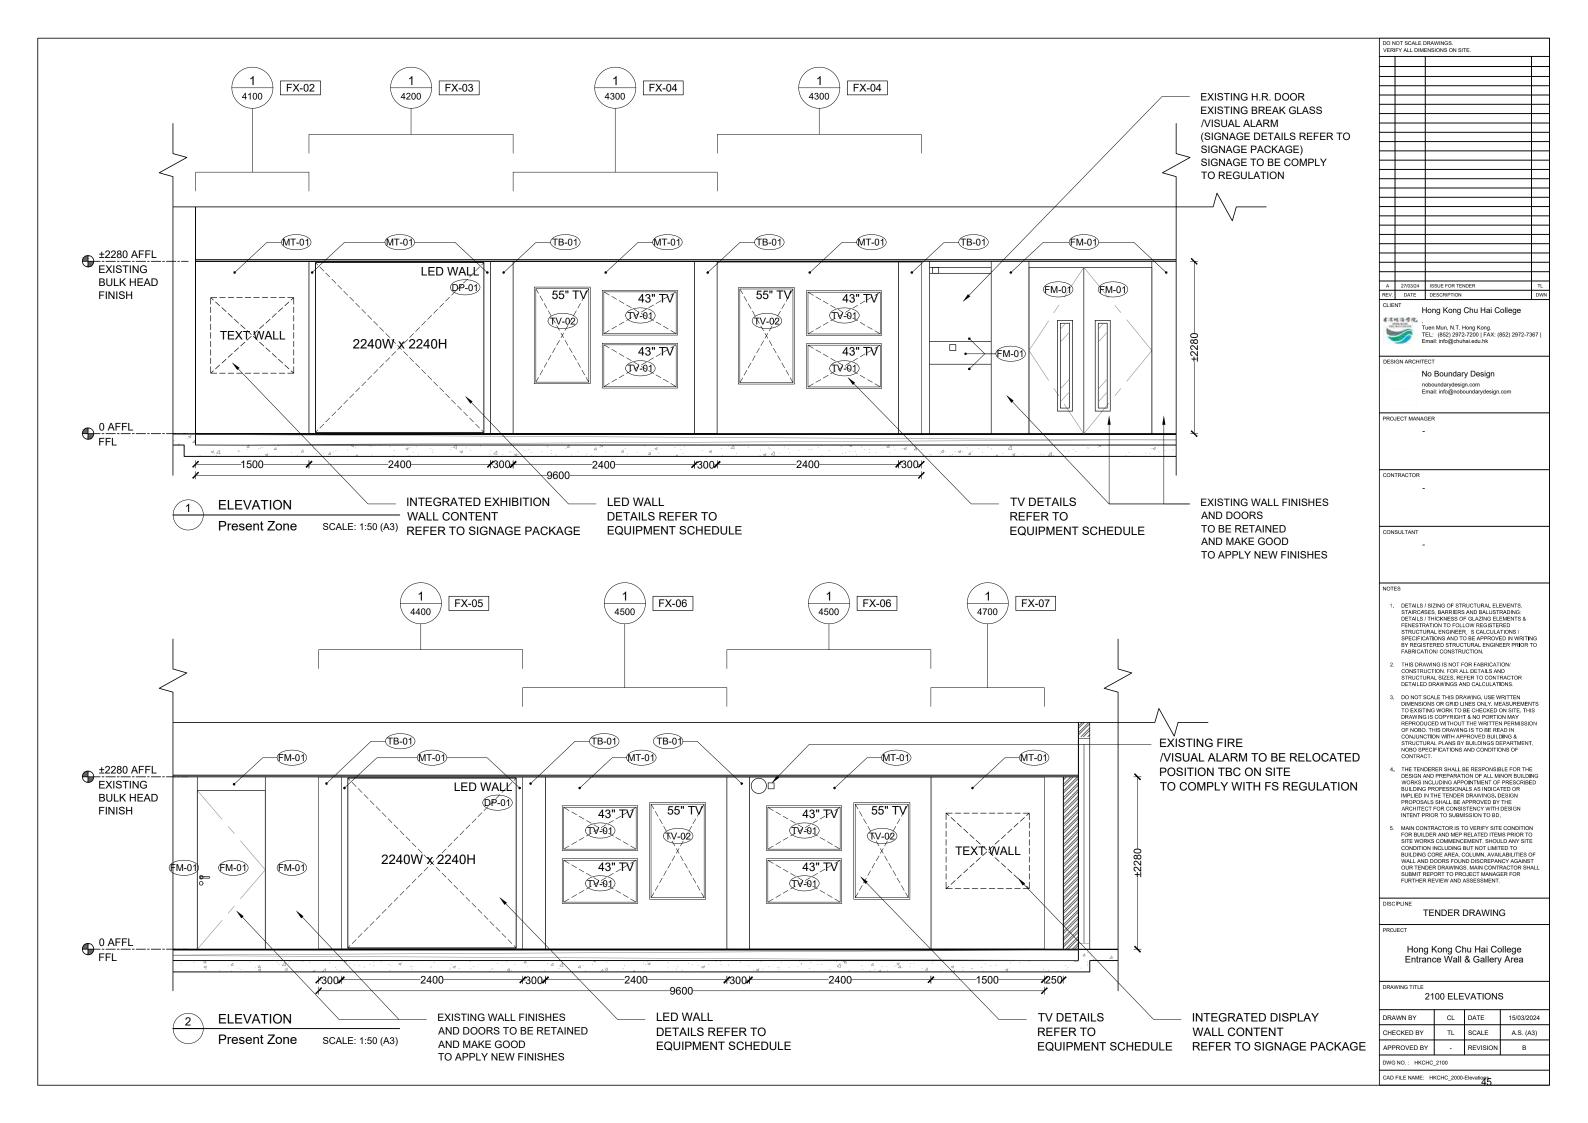

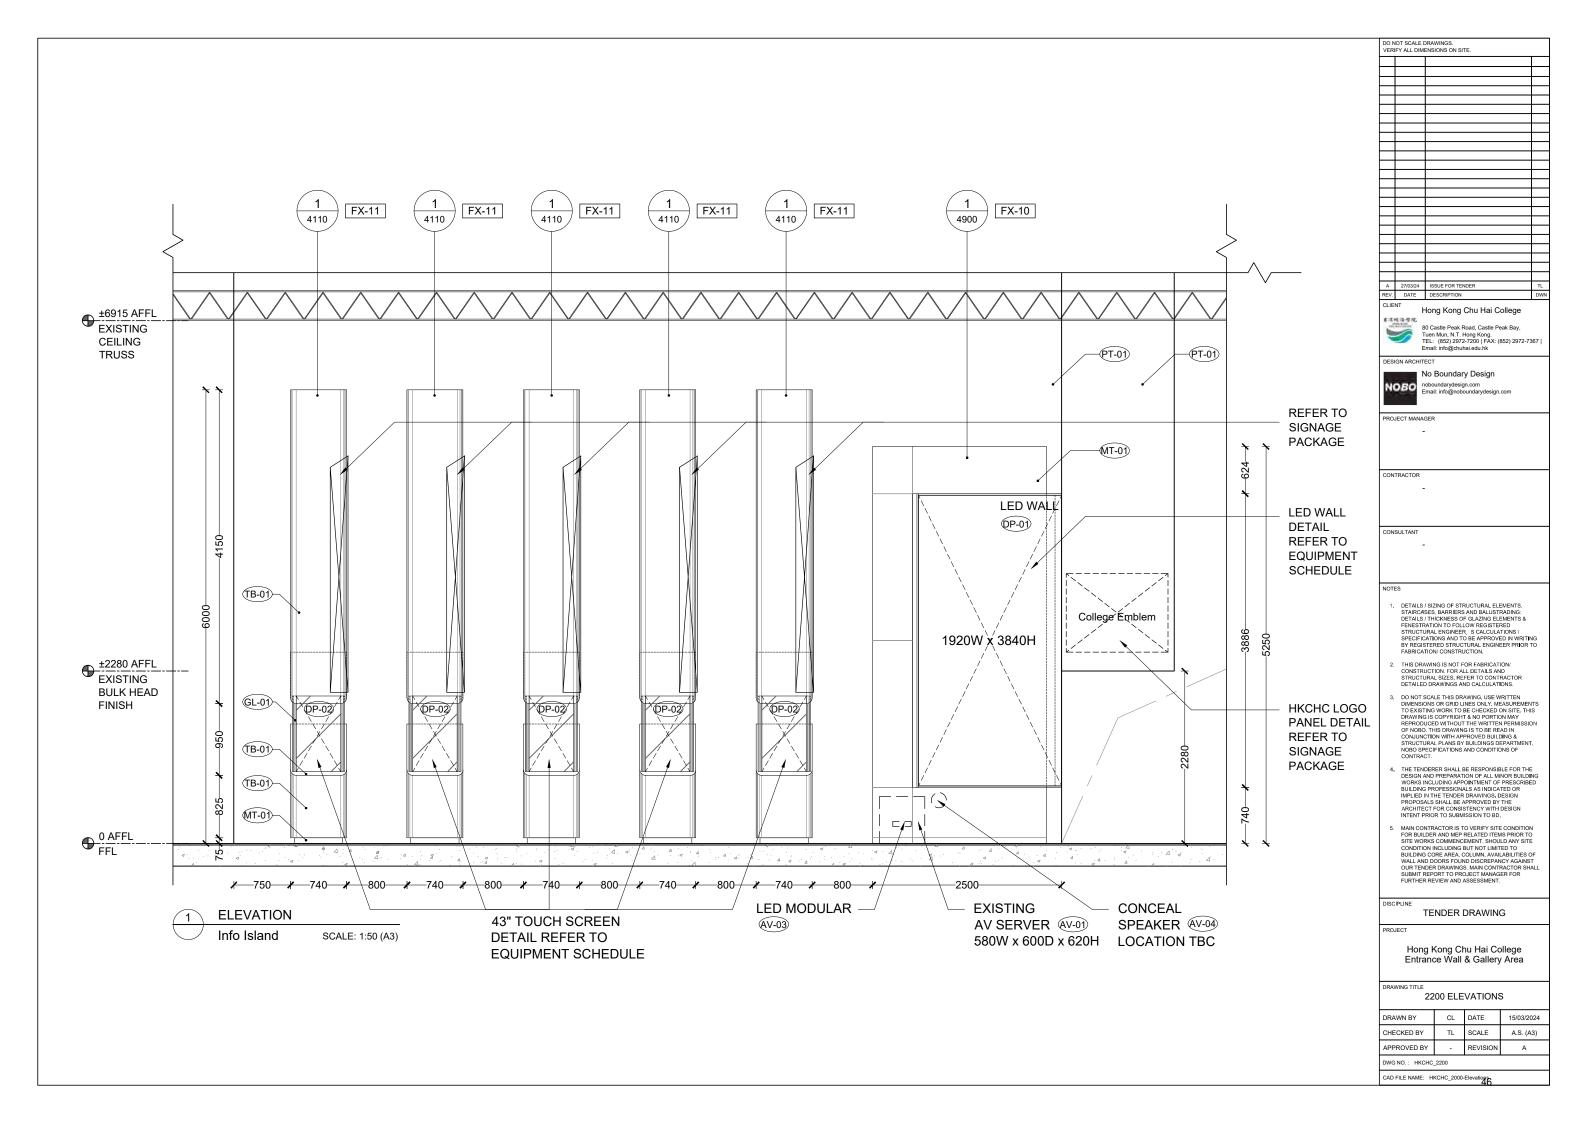

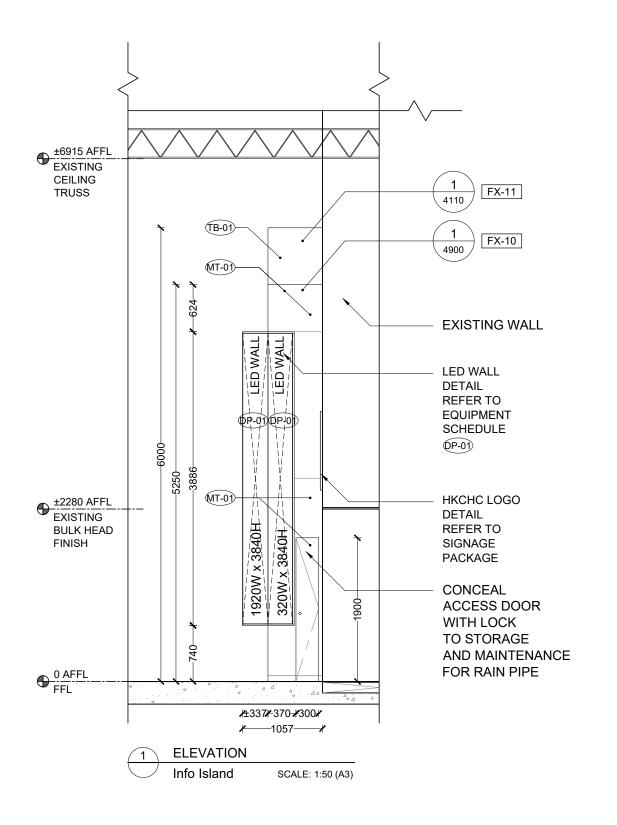

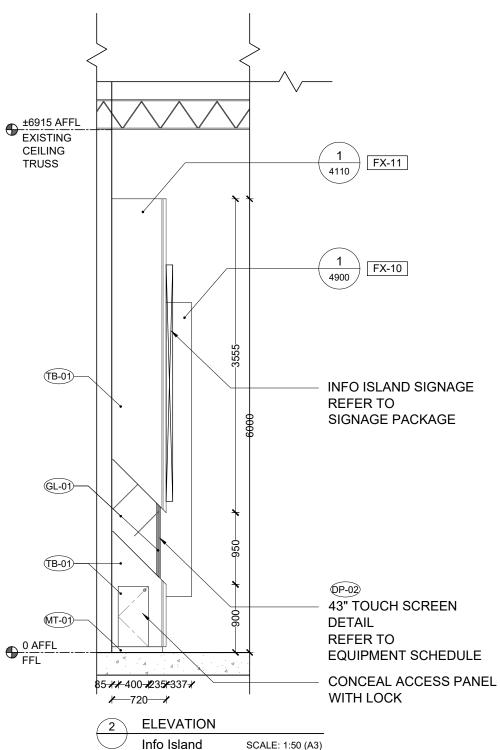

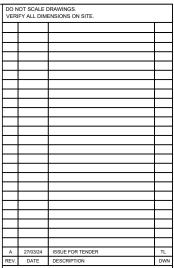

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Hong Kong Chu Hai College



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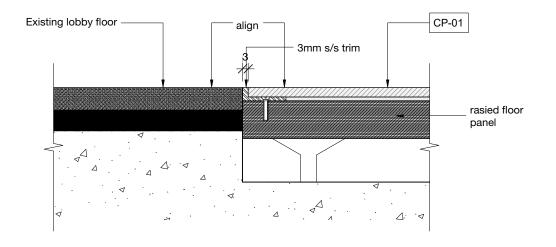
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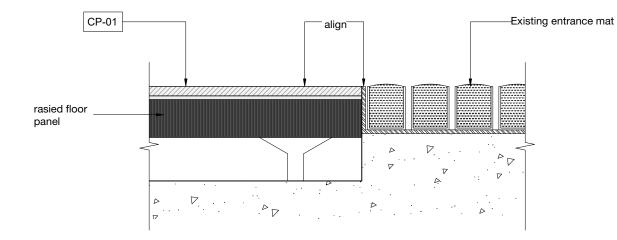
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2300 ELEVATIONS


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APPROVED BY	-	REVISION	А
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CAD FILE NAME: HKCHC_2000-Elevations







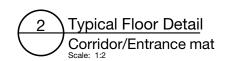

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DESIGN ARCHITECT



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PROJECT MANAGER

CONTRACTOR

CONSULTANT

NOTES

- NOTES

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PROJECT


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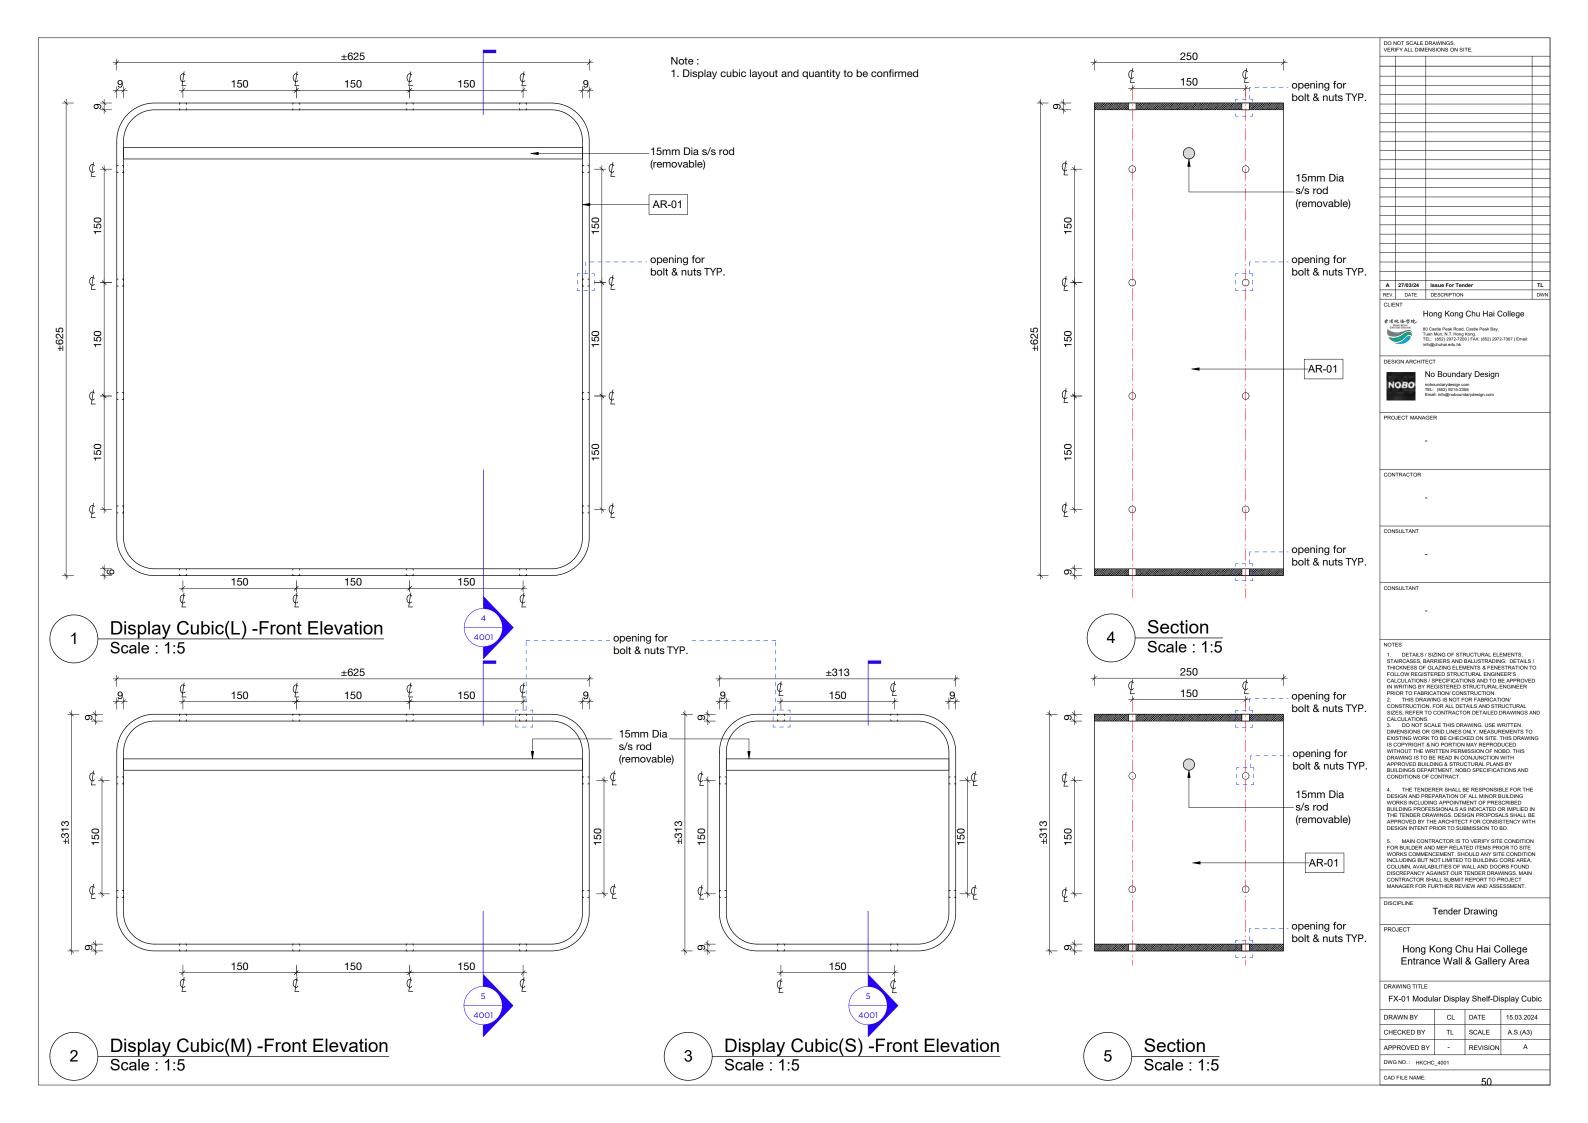
DRAWING TITLE


Typical Floor Details


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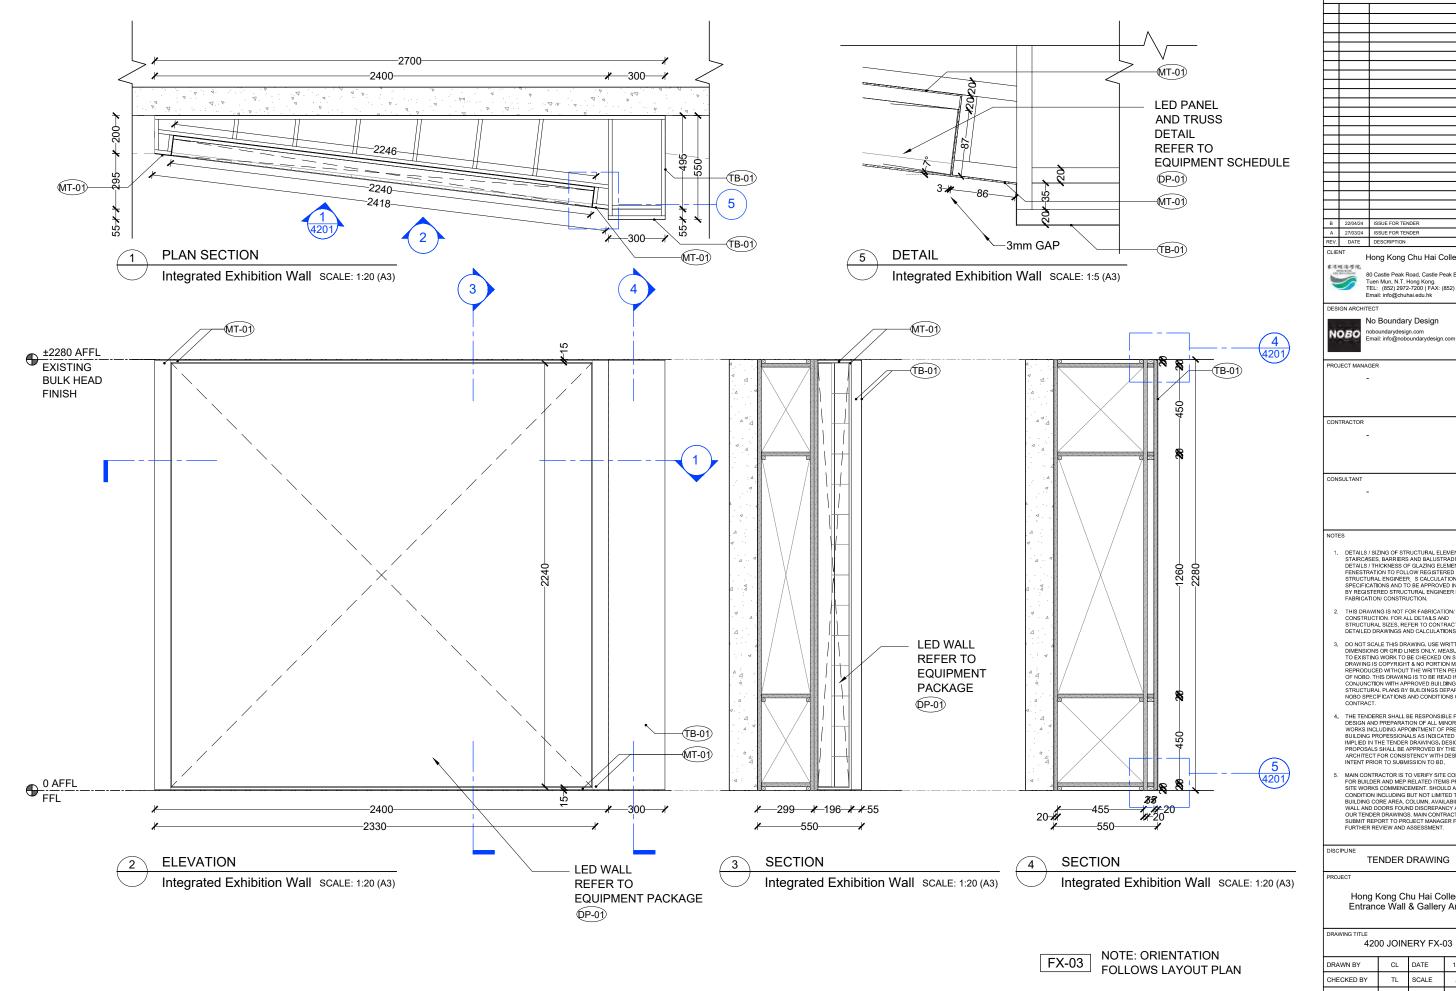
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Hong Kong Chu Hai College Entrance Wall & Gallery Area

4100 JOINERY FX-02

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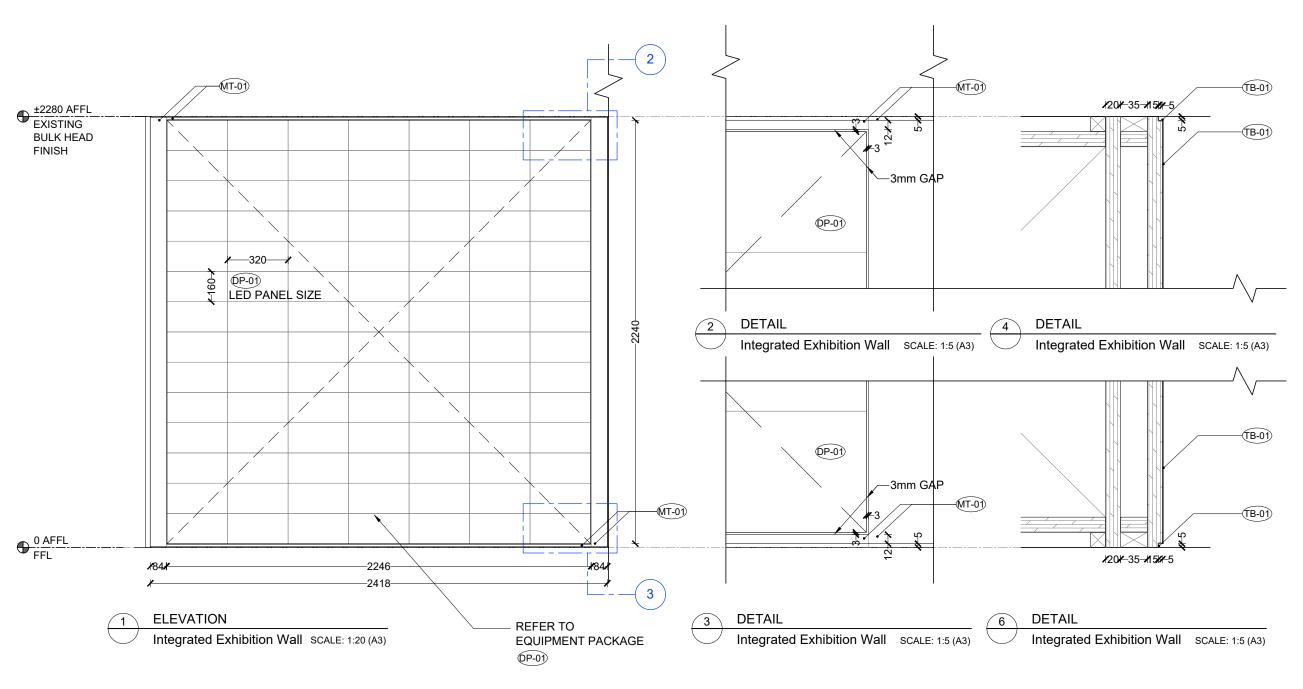
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Hong Kong Chu Hai College Entrance Wall & Gallery Area

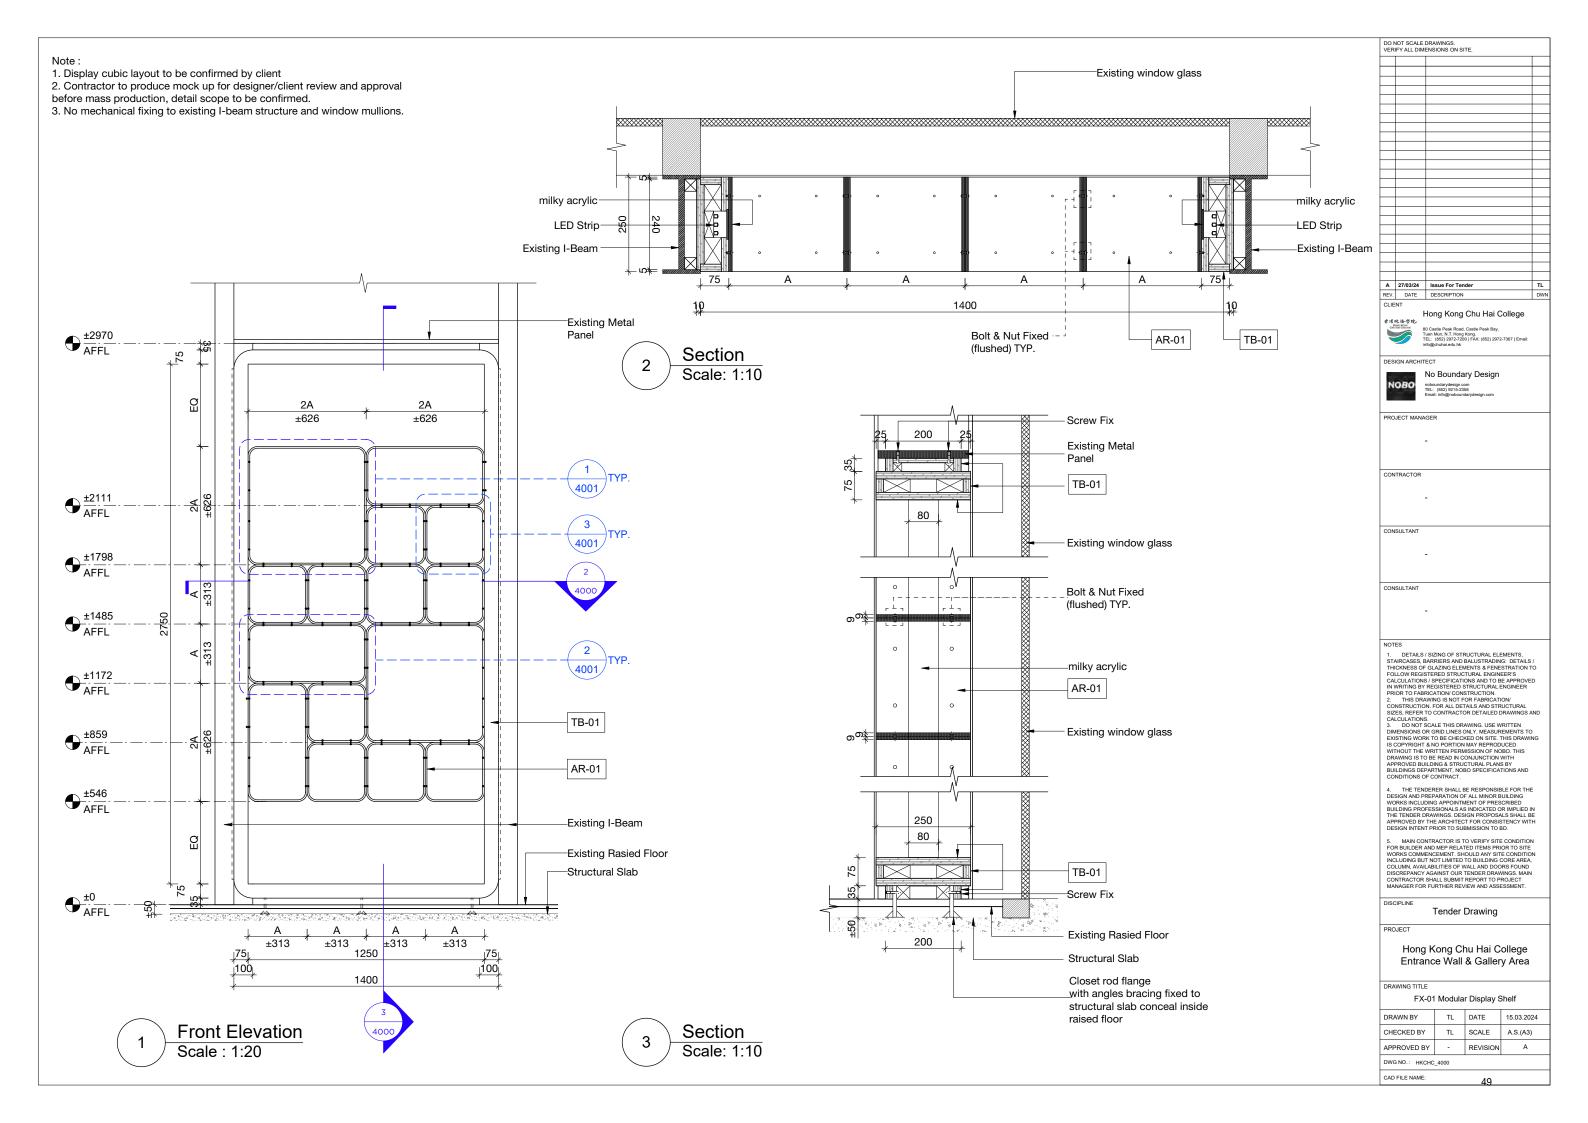DRAWN BY	CL	DATE	15/03/2024
CHECKED BY	TL	SCALE	A.S. (A3)
APPROVED BY	-	REVISION	Α
DWG NO.: HKCHC	_4200		
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Α	27/03/24	ISSUE FOR TENDER	TL
REV.	DATE	DESCRIPTION	DWN

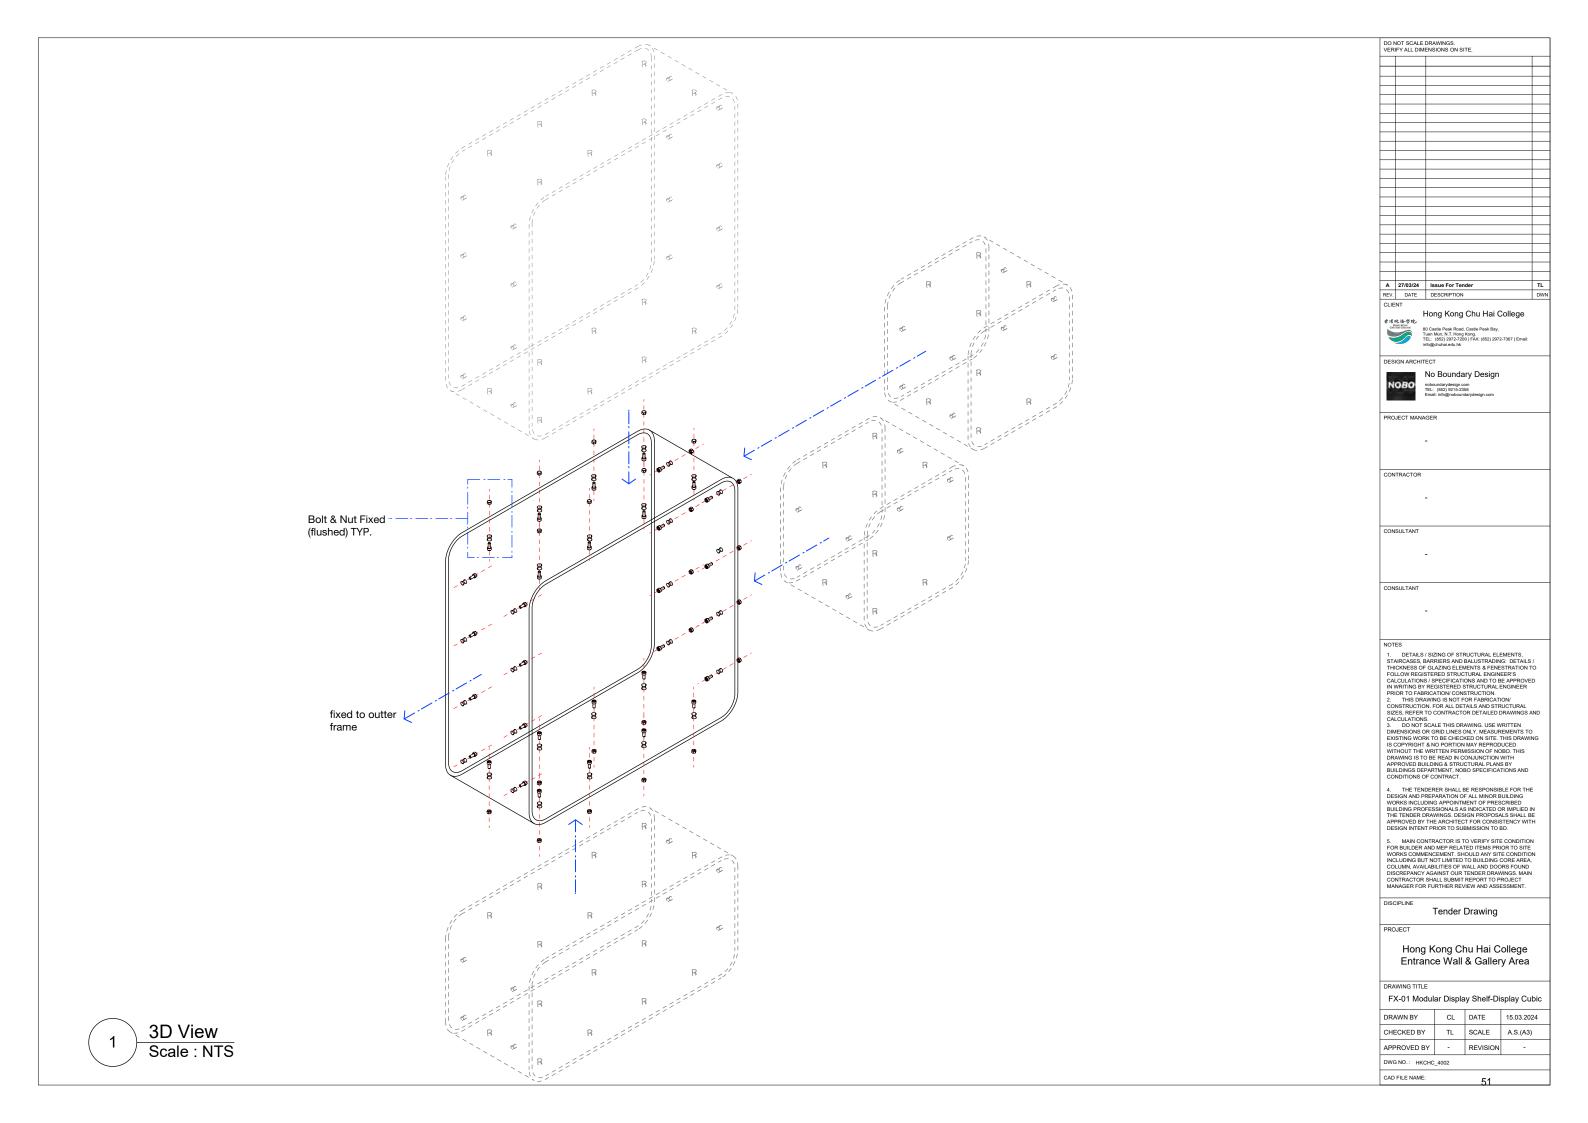CLIENT

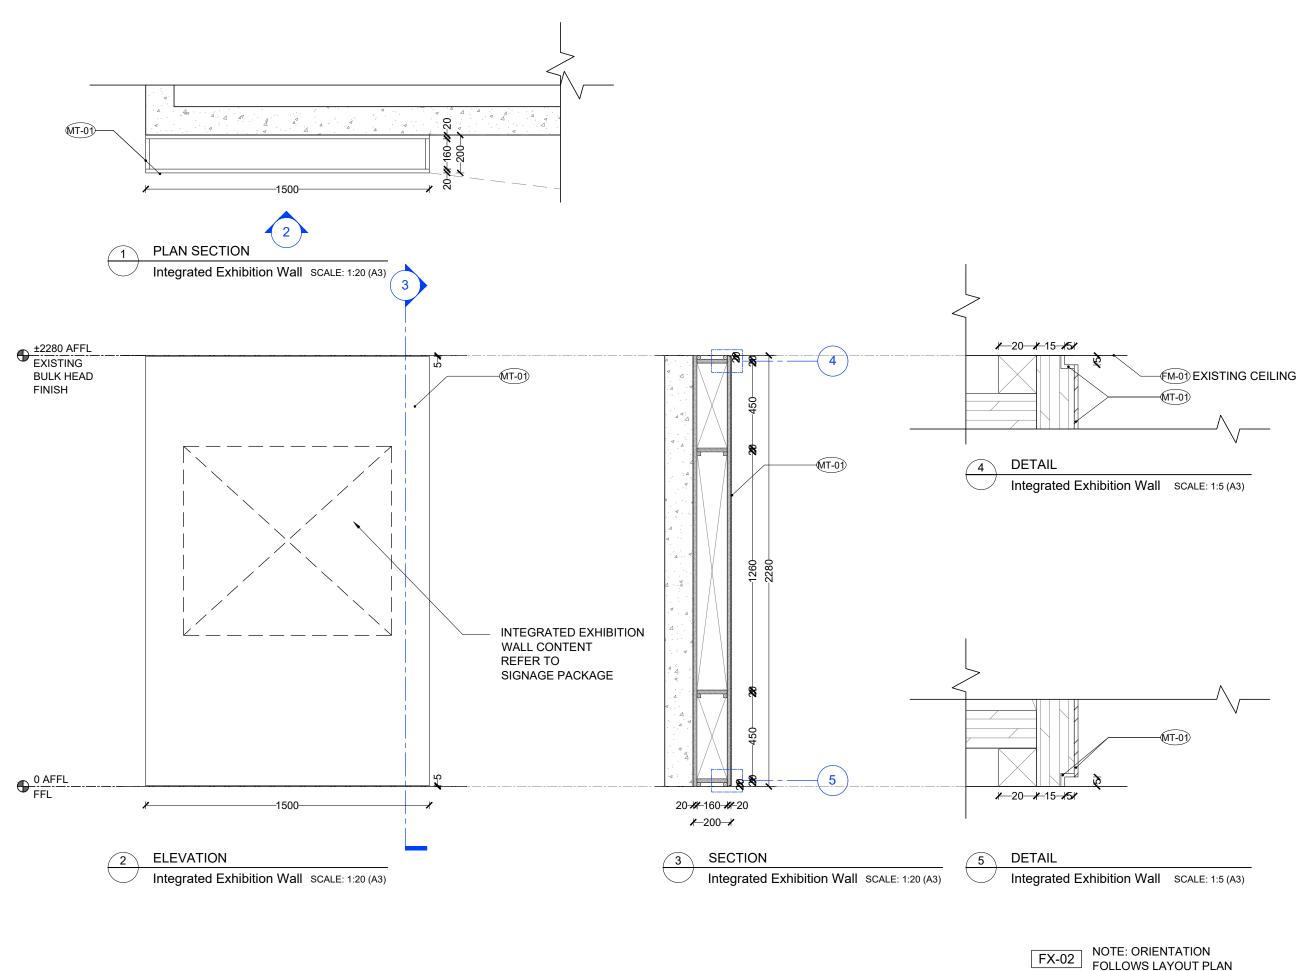Hong Kong Chu Hai College



80 Castle Peak Road, Castle Peak Bay, Tuen Mun, N.T. Hong Kong. TEL: (852) 2972-7200 | FAX: (852) 2972-7367 | Email: info@chuhai.edu.hk

DESIGN ARCHITECT

NOBO noi

No Boundary Design noboundarydesign.com Email: info@noboundarydesign.com

ROJECT MANAGER

CONTRACTOR

CONSULTAN

NOT

- DETAILS / SIZING OF STRUCTURAL ELEMENTS, STAIRCASES, BARRIERS AND BALUSTRADING: DETAILS / THICKNESS OF GLAZING ELEMENTS & FENESTRATION TO FOLLOW REGISTERED STRUCTURAL ENDINEER: S CALCULATIONS / SPECIFICATIONS AND TO BE APPROVED IN WRITING BY REGISTERED STRUCTURAL ENGINEER PRIOR TO FABRICATION; CONSTRUCTION.
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- DE I PILLED DRAWINGS AND CALCULATIONS.

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DISCIPLINE

TENDER DRAWING

PROJE

NOTE: ORIENTATION FOLLOWS LAYOUT PLAN


Hong Kong Chu Hai College Entrance Wall & Gallery Area

DRAWING TITI

4201 JOINERY FX-03

DRAWN BY	CL	DATE	15/03/2024
CHECKED BY	TL	SCALE	A.S. (A3)
APPROVED BY	-	REVISION	Α

DWG NO.: HKCHC_42

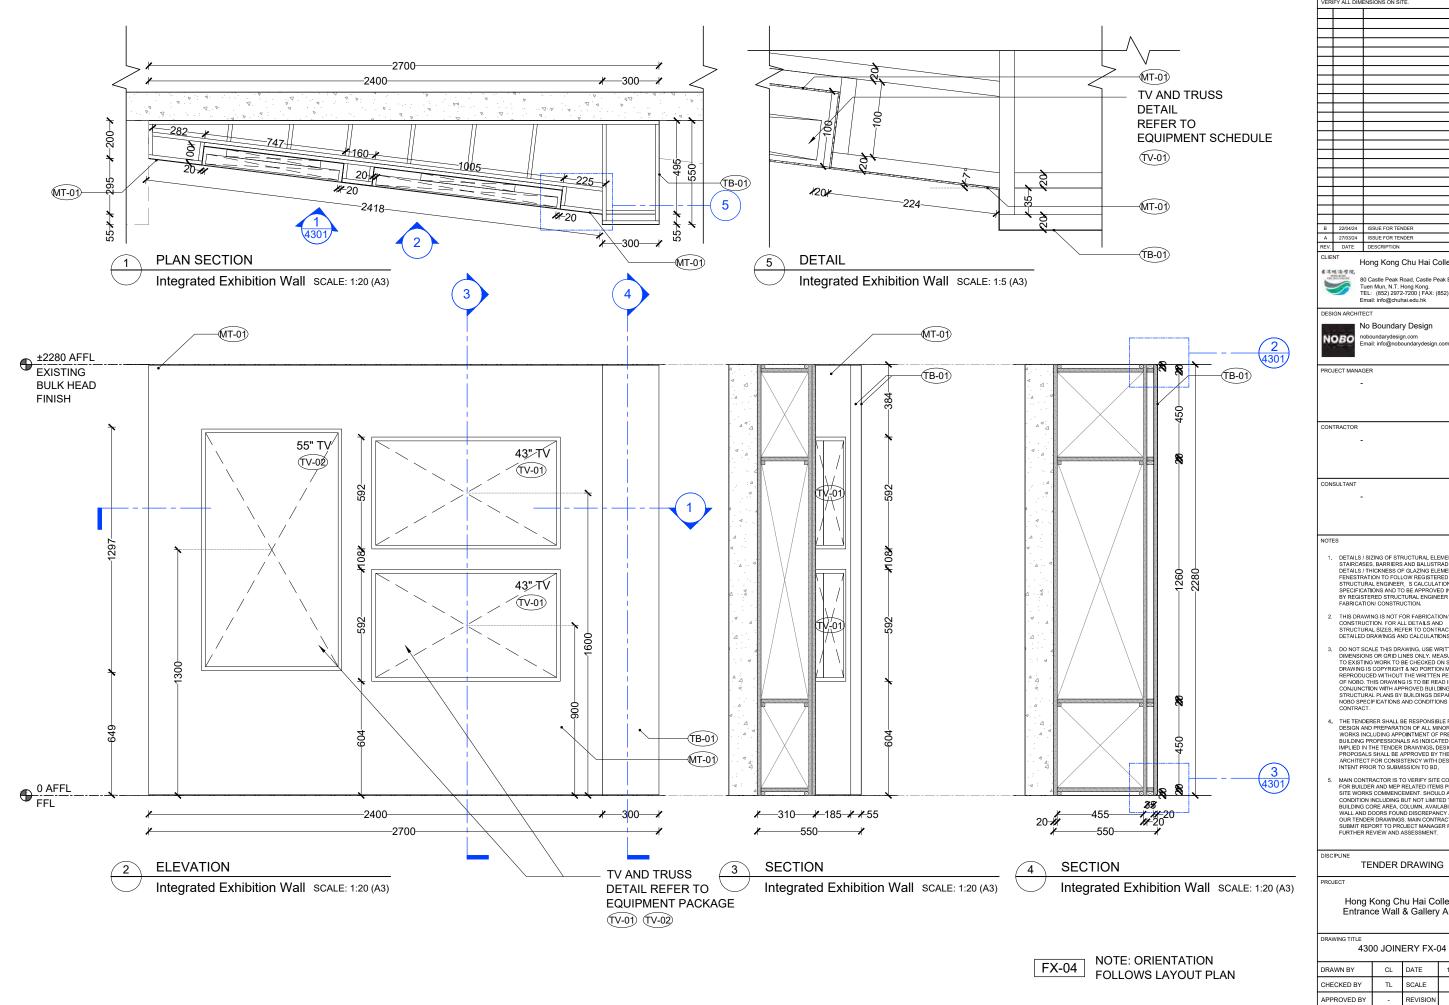

DO NOT SCALE DRAWINGS. VERIFY ALL DIMENSIONS ON SITE.

80 Castle Peak Road, Castle Peak Bay, Tuen Mun, N.T. Hong Kong. TEL: (852) 2972-7200 | FAX: (852) 2972-7367 Email: info@chuhai.edu.hk


noboundarydesign.com Email: info@noboundarydesign.com

- DETAILS / SIZING OF STRUCTURAL ELEMENTS, STARICASES, BARRIERS AND BALUSTRADING: DETAILS / THICKNESS OF GLAZING ELEMENTS & FENESTRATION TO FOLLOW REGISTERED STRUCTURAL ENGINEER, SCALCULATIONS / SPECIFICATIONS AND TO BE APPROVED IN WRITING BY REGISTERED STRUCTURAL ENGINEER PRIOR TO FABRICATION CONSTRUCTION.
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Hong Kong Chu Hai College Entrance Wall & Gallery Area

DRAWN BY	CL	DATE	15/03/2024
CHECKED BY	TL	SCALE	A.S. (A3)
APPROVED BY	-	REVISION	Α
DWG NO.: HKCHC	_4300		



NOTE: ORIENTATION FOLLOWS LAYOUT PLAN

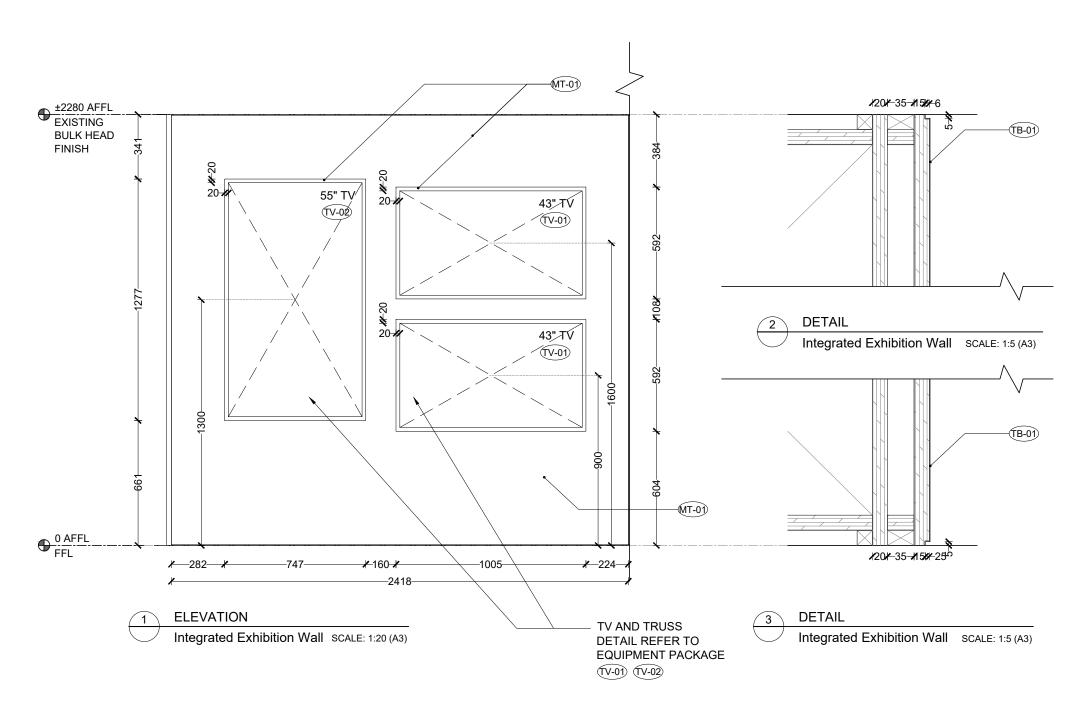REV.	DATE	DESCRIPTION	
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Hong Kong Chu Hai College



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DESIGN ARCHITECT



No Boundary Design noboundarydesign.com Email: info@noboundarydesign.com

CONTRACTOR

CONSULTANT

- DETAILS / SIZING OF STRUCTURAL ELEMENTS, STAIRCASSES, BARRIERS AND BALUSTRADING: DETAILS / THICKNESS OF GLAZINS ELEMENTS & FENESTRATION TO FOLLOW REGISTERED STRUCTURAL ENGINEER S CALCULATIONS / SPECIFICATIONS AND TO BE APPROVED IN WRITING BY REGISTERED STRUCTURAL ENGINEER PRIOR TO FABRICATION/ CONSTRUCTION.
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 FURTHER REVIEW AND ASSESSMENT.


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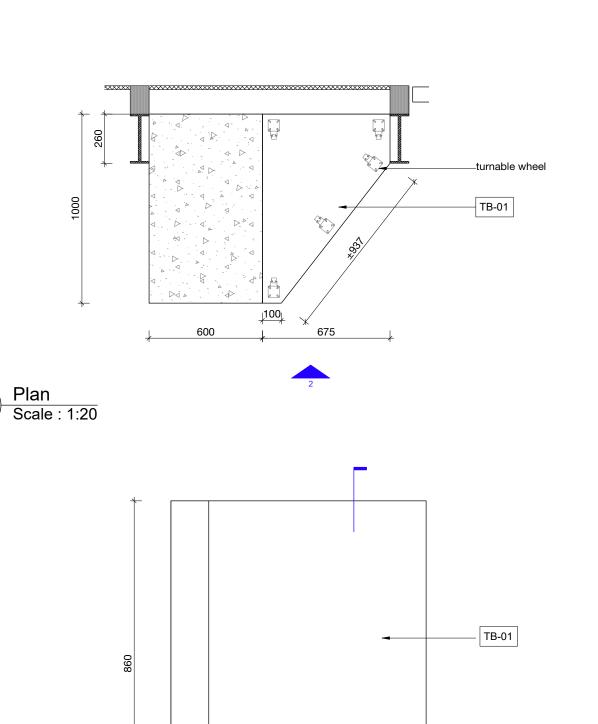
TENDER DRAWING

Hong Kong Chu Hai College Entrance Wall & Gallery Area

4301 JOINERY FX-04

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APPROVED BY	-	REVISION	Α				
BUILD HO LIVELING 1991							



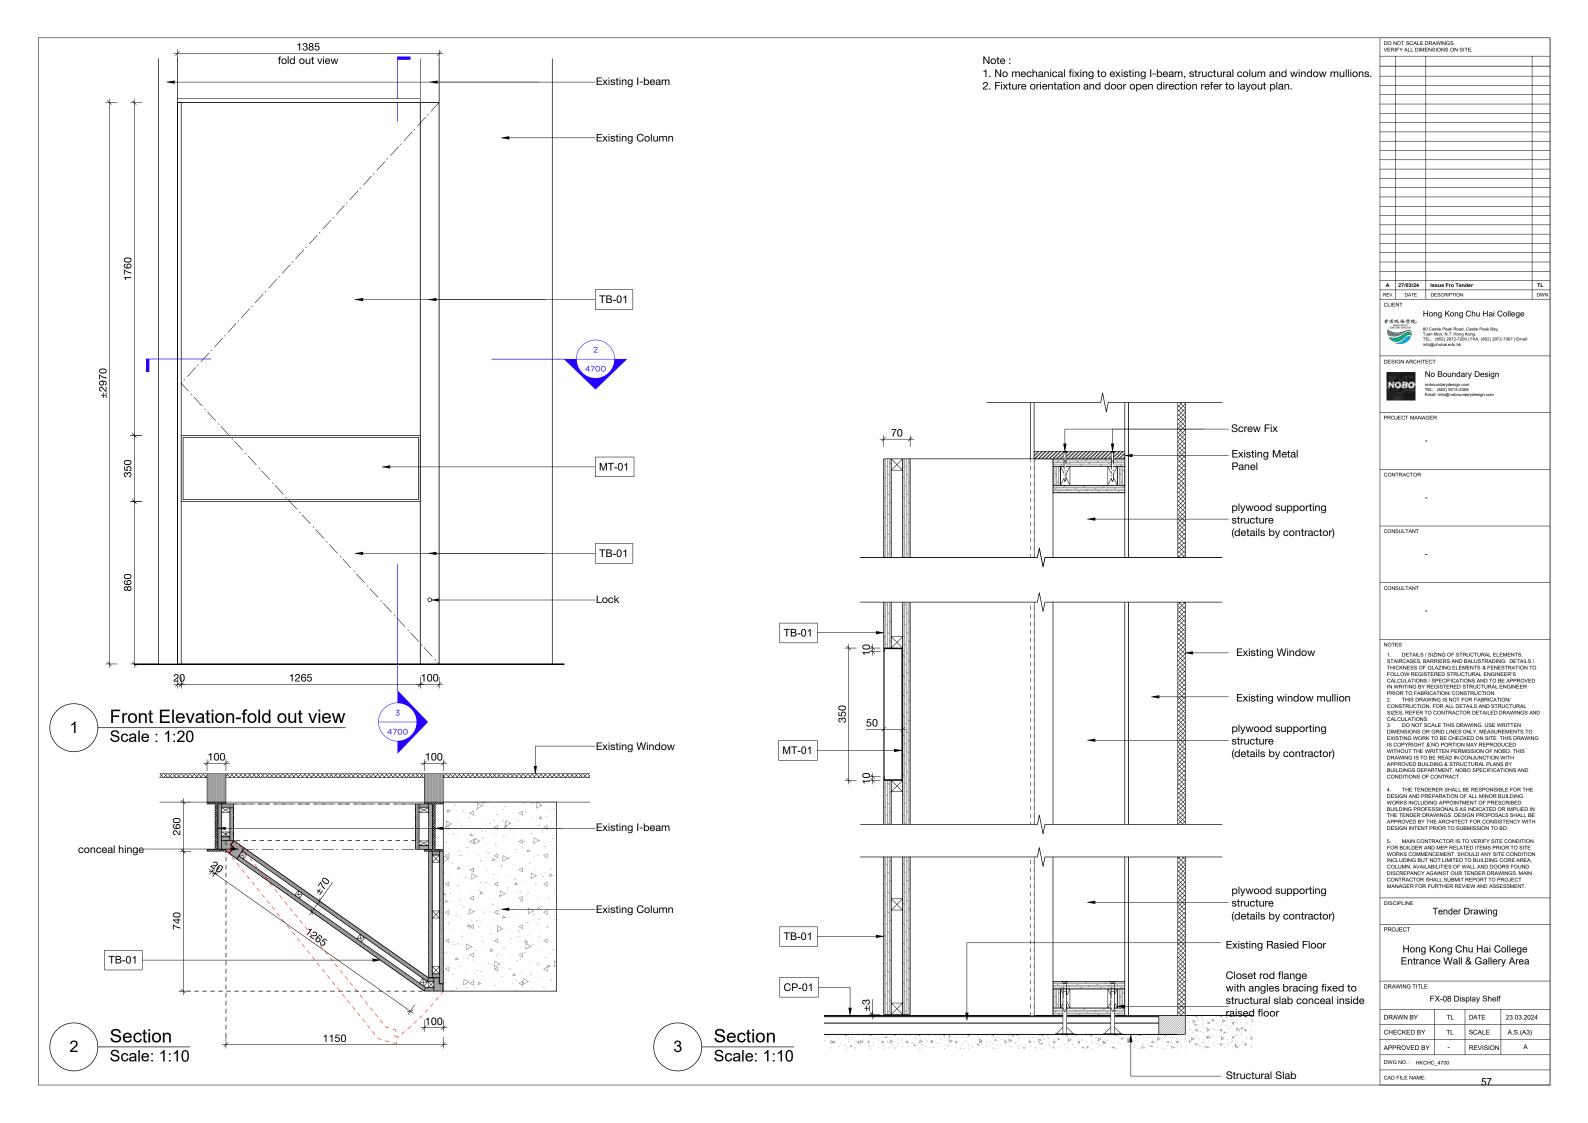

675

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Elevation

Scale: 1:10

TB-01 TB-01 turnable wheel

675

Section Scale: 1:10 Note:

- 1. No mechanical fixing to existing I-beam, structural colum and window mullions.
- 2. Fixture orientation and door open direction refer to layout plan.

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Α	27/03/24	Issue Fro Tender	TL
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DESIGN ARCHITECT



No Boundary Design

PROJECT MANAGER

CONTRACTOR

CONSULTANT

NOTES

- NOTES

 1. DETAILS / SIZING OF STRUCTURAL ELEMENTS.
 STAIRCASES, BARRIERS AND BALUSTRADING: DETAILS /
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Tender Drawing

DISCIPLINE

PROJECT

Hong Kong Chu Hai College Entrance Wall & Gallery Area

DRAWING TITLE


FX-08 Display Shelf


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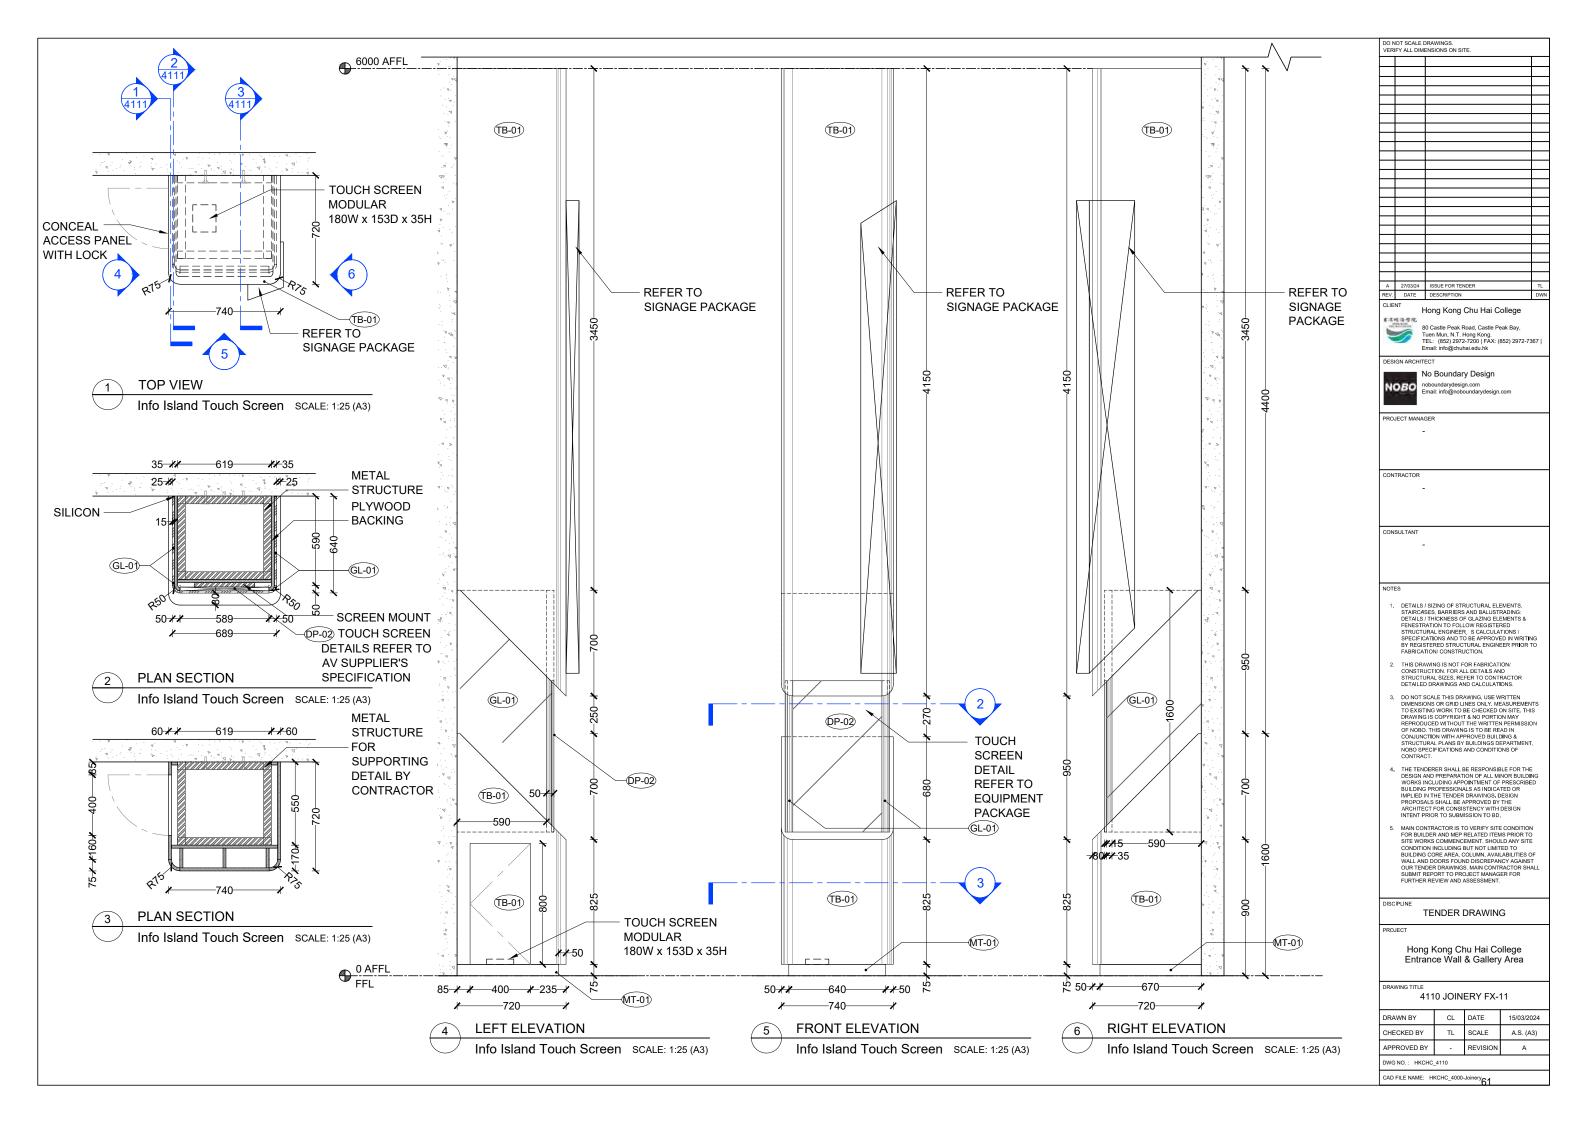
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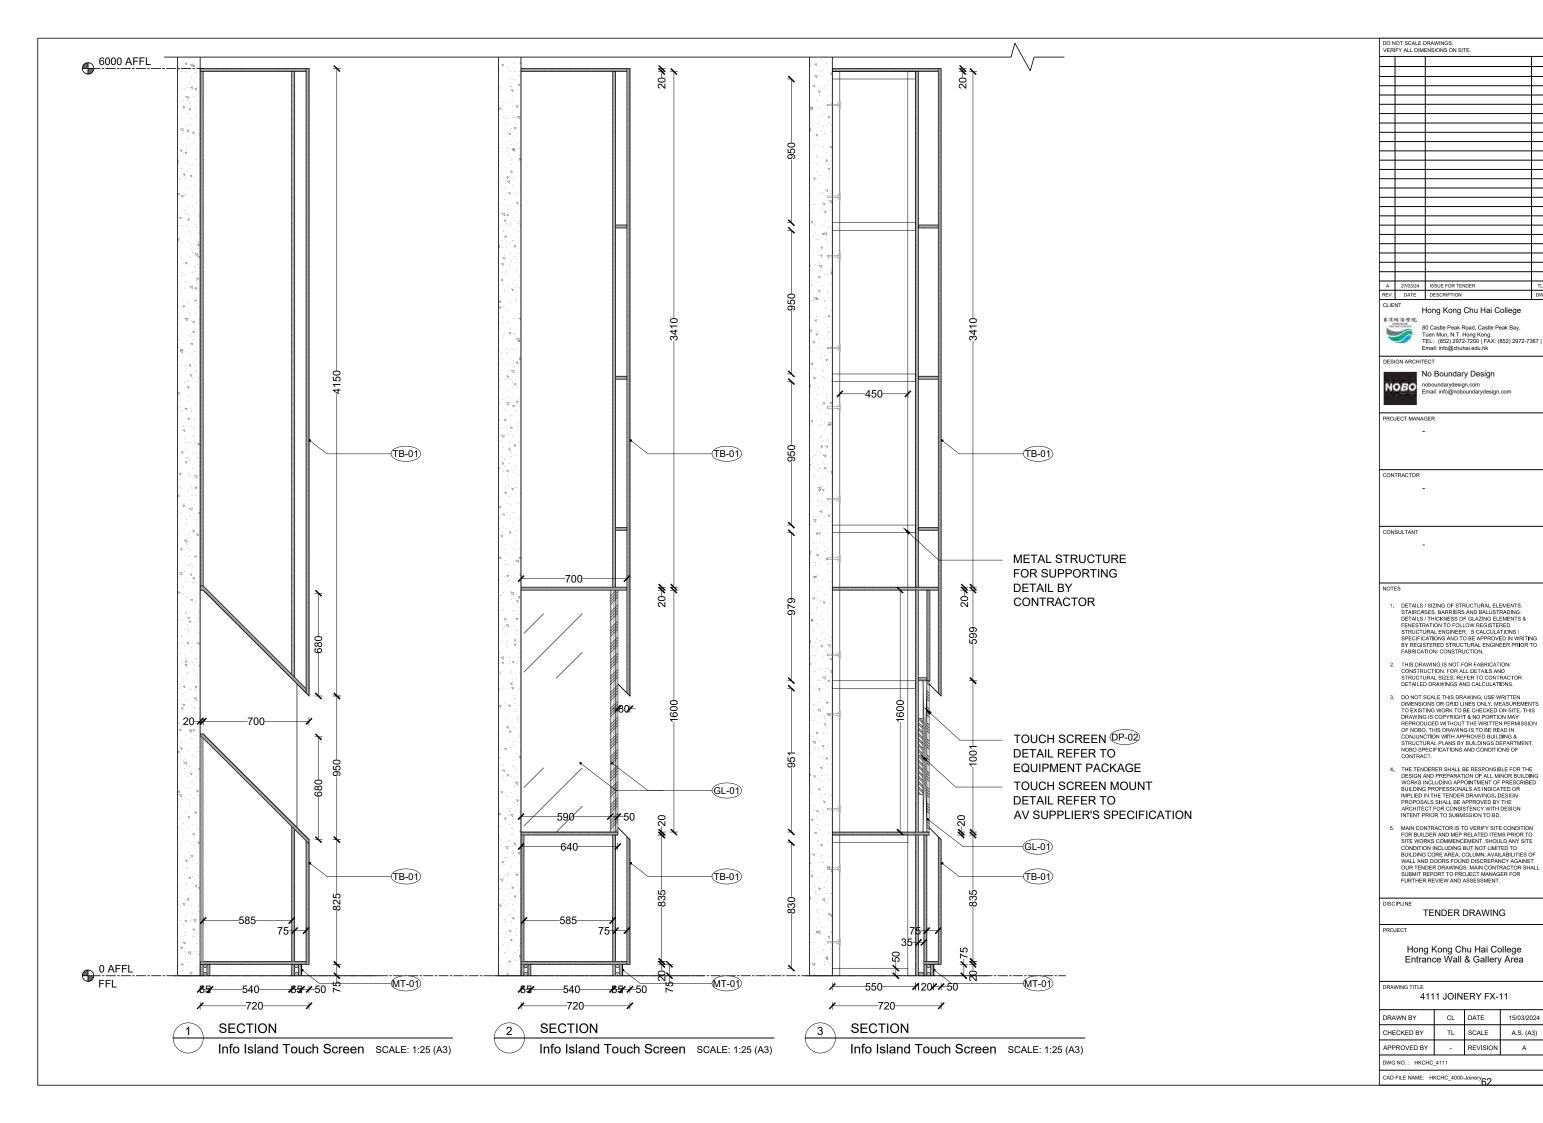
CAD FILE NAME:

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15/03/2024

A.S. (A3)

6000 | Material Schedule

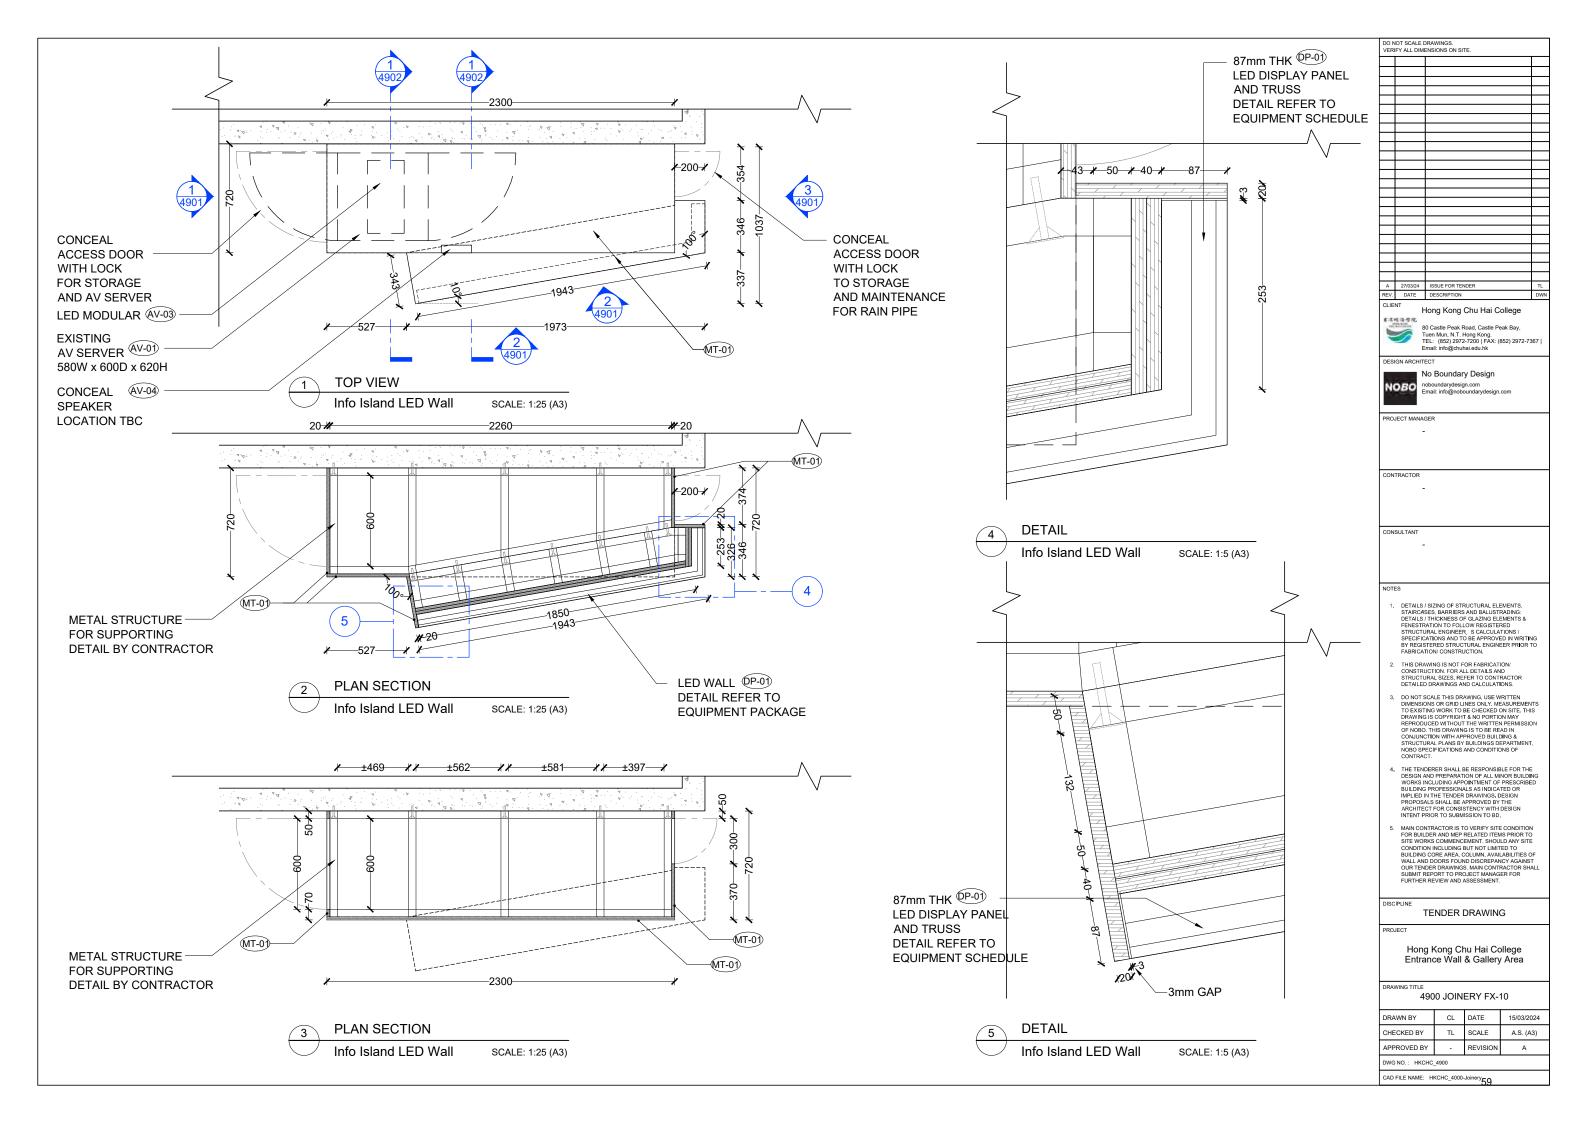Client

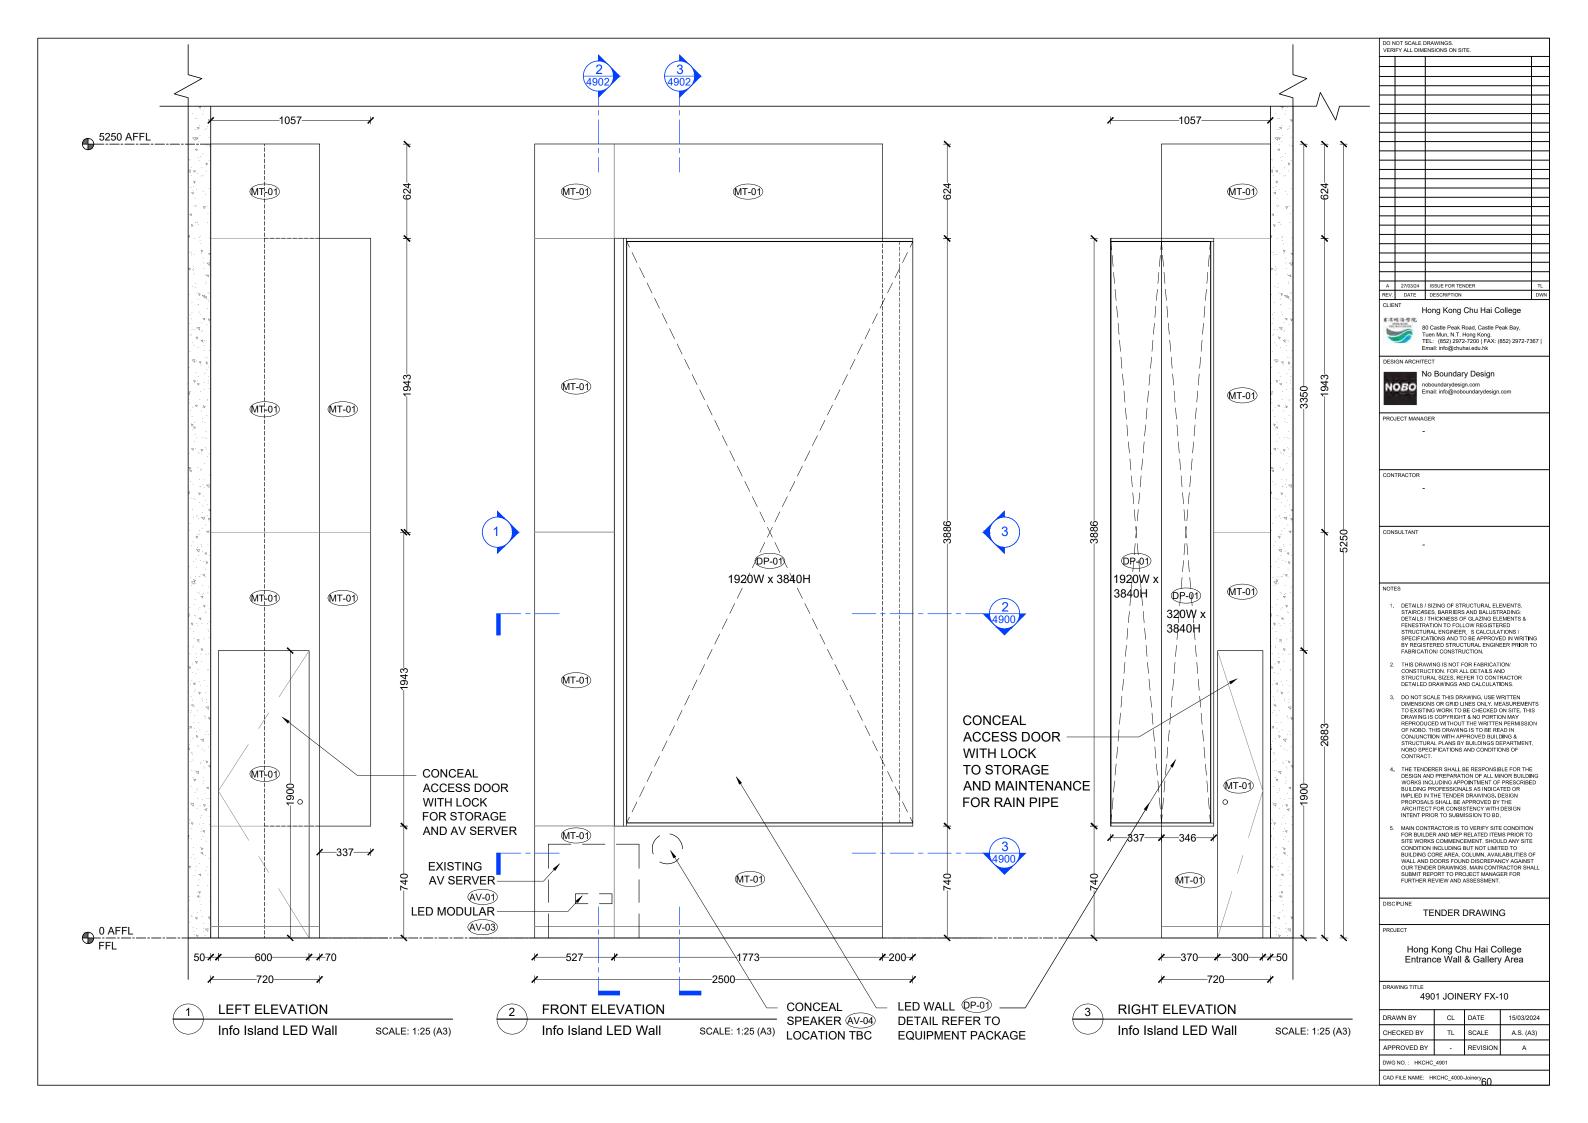Hong Kong Chu Hai College 80 Castle Peak Road, Castle Peak Bay Tuen Mun, N.T.

Tuen wun, N. I.

Tel: (852) 2972 7200

Email: info@chuhai.edu.hk

Design Architect No Boundary Design noboundraydesign.com

Tel: (852) 9215 2356

Email: info@noboundarydesign.com

Contact

Ken Lee <u>ken@noboundarydesign.com</u>

Issue	Date	Revision
Δ		27/3/2024 Issue For Tender

Notes:

All specifications to meet equivalent local codes and requirements in addition to those outlined in this document.

Contractor to advise of any proposed material or equipment substitutes prior to procurement. Samples of all finishes to be approved by client and architect prior to construction.

This schedule is to be read in conjunction with the architectural specification.

Refer to Architect drawings for further details and extent and location of materials.

Item	Code	Location	Image Reference	Description	Notes	Supplier
Arcylic Panel	AR-01	Modular Display Shelf		5mm Acrylic Shelfings with embedded light strip	Refer to HK Architectural Services department General Specifications for Building 2022 See manufacturer's specification Contractor to submit a sample for Deigner approval	Refer to designer's sample
Carpet Tile	CP-01	Gallery Area		Carpet Tile Size: 500mm x 500mm	Refer to HK Architectural Services department General Specifications for Building 2022 See manufacturer's specification Contractor to submit a sample for Deigner approval	Refer to designer's sample
Film	FM-01	Existing Gallery Area Wall and Ceiling Finish		3M Sticker Color to match with MT-01	Refer to HK Architectural Services department General Specifications for Building 2022 See manufacturer's specification Contractor to submit a sample for Deigner approval	Refer to designer's sample

Entrance v	wan and Ga	liery Area			
Glass	GL-01	Info Island	Clear Mirror	Refer to HK Architectural Services department General Specifications for Building 2022 See manufacturer's specification Contractor to submit a sample for Deigner approval	Refer to designer's sample
Metal	MT-01	Atrium LED Wall, Exhibition Wall, Display Shelf	Dark Gun Metal Panel	Refer to HK Architectural Services department General Specifications for Building 2022 See manufacturer's specification Contractor to submit a sample for Deigner approval	Refer to designer's sample
Timber Vene	TB-01	Display Shelf Exhibition Wall Info Island	American Walnut Veneer	Refer to HK Architectural Services department General Specifications for Building 2022 See manufacturer's specification Contractor to submit a sample for Deigner approval	Refer to designer's sample
Paint	PT-01	Existing Atrium Wall Finish	Color to match existing wall	Refer to HK Architectural Services department General Specifications for Building 2022 See manufacturer's specification Contractor to submit a sample for Deigner approval	Refer to designer's sample

Entrance Wall and Gallery Area							
RB-01	Gallery Area	TBC	Top to floor	work to be checked on	TBC Proposed by Client and Contractor		
RB-02	Gallery Area	TBC	Top to window mullion	work to be checked on	TBC Proposed by Client and Contractor		
	RB-01	RB-01 Gallery Area	RB-01 Gallery Area TBC	RB-01 Gallery Area TBC Electrical Roller Blind Top to floor Electrical Roller Blind Top to window mullion	RB-01 Gallery Area TBC Electrical Roller Blind Top to floor work to be checked on site. Electrical Roller Blind Work to be checked on site. Electrical Roller Blind Measurements to existing work to be checked on site.		

Sheet	No.:	6000

6100 | Lighting Schedule

Client

Hong Kong Chu Hai College 80 Castle Peak Road, Castle Peak Bay

Tuen Mun, N.T.

Tel: (852) 2972 7200

Email: info@chuhai.edu.hk

Design Architect No Boundary Design noboundraydesign.com

Tel: (852) 9215 2356

Email: info@noboundarydesign.com

Contact

Ken Lee <u>ken@noboundarydesign.com</u>

Issue	Date	Revision	
Δ		27/3/2024 Issue For Tender	

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Refer to Architect drawings for further details and extent and location of materials.

Item	Code	Location	Image Reference	Description	Notes	Supplier
Tracklight	LT-01	Atrium		Spotlight for Logo Customised 39W tacklight, spot beam 9°, 3500K, CRI93, anti-glare hood (flat type) remote 0/1-10V dimmable control via Apps & handy remote control. Black/sliver grey finsh, provide with surface mounted track. (Quantity: 1)		HAKA Lighting Email: hoi.tam@hakahk.com Tel: 4608 1664
Tracklight	LT-02	Atrium		Spotlight for Ambience Enhancement Customised 39W tacklight, based angle spot beam 11° with semi spread lens 34°, 3500K, anti-glare hood (flat type) remote 0/1-10V dimmable control via Apps & handy remote control. Black/sliver grey finsh, provide with surface mounted track. (Quantity: 2)		HAKA Lighting Email: hoi.tam@hakahk.com Tel: 4608 1664
Tracklight	LT-03	Gallery Area		Gallery 48V Track Spotlight 12W , 3000K, CRI90, 0/1-10V dimmable control, provide with H-track (Quantity: 23)		HAKA Lighting Email: hoi.tam@hakahk.com Tel: 4608 1664

	indunes train and earlery rued							
Tracklight	LT-04 (Optio n 1)	Gallery Area		Gallery 48V Wallwasher 13W , 3000K, CRI90, 0/1-10V dimmable control, provide with H-track Quantity: 17		HAKA Lighting Email: hoi.tam@hakahk.com Tel: 4608 1664		
Tracklight	LT-04 (Optio n 2)	Gallery Area	Sala Sala Sala Sala Sala Sala Sala Sala	Gallery 48V Wallwasher (adjustable) 14W , 3000K, CRI90, 0/1-10V dimmable control, provide with H-track		HAKA Lighting Email: hoi.tam@hakahk.com Tel: 4608 1664		
Downlight	LT-05	Gallery Area		Gallery Adjustable Recessed Downlight 15W, 3000K, CRI90, 0/1-10V Dimmable Control Quantity: 14 (existing downlight cut-hole)	Refer to HK Architectural Services department General Specifications for Building 2022 See manufacturer's specification Contractor to submit a sample for Deigner approval	ONA Lighting Email: hoi.tam@hakahk.com Tel: 4608 1664		
LED Light Strip	LT-06	Modular Display Shelf		10W Linear LED x 1000mmL 3000K, CRI90, 0/1-10V Dimmable Control Quantity: 24 (4 per carbinet)	Refer to HK Architectural Services department General Specifications for Building 2022 See manufacturer's specification Contractor to submit a sample for Deigner approval	HAKA Lighting Email: hoi.tam@hakahk.com Tel: 4608 1664		

Entrance Wall and Gallery Area								

6200 | Equipment Schedule

Client

Hong Kong Chu Hai College 80 Castle Peak Road, Castle Peak Bay

Tuen Mun, N.T.

Tel: (852) 2972 7200

Email: info@chuhai.edu.hk

Design Architect No Boundary Design noboundraydesign.com

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Contact

Ken Lee <u>ken@noboundarydesign.com</u>

Issue	Date	Revision
Δ	27/3/2024 Issue For Tender	

Notes:

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Contractor to advise of any proposed material or equipment substitutes prior to procurement.

Samples of all finishes to be approved by client and architect prior to construction.

This schedule is to be read in conjunction with the architectural specification.

Refer to Architect drawings for further details and extent and location of materials.

Material Schedule Sheet No.: 6000

Item	Code	Location	Image Reference	Description	Notes	Supplier
LED Screen Panel	DP-01	LED Wall, Exhibition Wall		Screen Panel Size: 360mm x 160mm Thickness: 15mm Screen clearance:3mm		广东联合制造科技有限公司 梁建广 Tel: +86 13510842521 Email: leung21@yeah.net www.unite-mfg.com Address: 广东省深圳市宝安区 宝田二路2号臣田工业区28栋3层
Touch Screen	DP-02	Info Island	P. B. S. A. S.	定制:智能魔镜 43寸触摸屏 Overall Size: 1001mmW x 589mmH x 25mmD Glass Thickness: 3mm Modular Size: H35*180W*153L Quantity: 5		广东联合制造科技有限公司 梁建广 Tel: +86 13510842521 Email: leung21@yeah.net www.unite-mfg.com Address: 广东省深圳市宝安区 宝田二路2号臣田工业区28栋3层
TV	TV-01	Exhibition Wall	A STATE OF THE STA	43" Overall Size: 964.6mmW x 551.8mmH x 52.8mmD Quantity: 8		广东联合制造科技有限公司 梁建广 Tel: +86 13510842521 Email: leung21@yeah.net www.unite-mfg.com Address: 广东省深圳市宝安区 宝田二路2号臣田工业区28栋3层

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TV	TV-02	Exhibition Wall	A HIT	55" Overall Size: 1237.4mmW x 707.2mmH x 52.8mmD Quantity: 4		广东联合制造科技有限公司 梁建广 Tel: +86 13510842521 Email: leung21@yeah.net www.unite-mfg.com Address: 广东省深圳市宝安区 宝田二路2号臣田工业区28栋3层
Existing AV Server	AV-01	Inside Atrium LED Wall		Size: 580mmW x 600mmD x 620mmH	N/A	N/A
Existing Speaker	AV-02	Inside Atrium LED Wall		Size: 500mmW x 300mmD x 300mmH	N/A	N/A
LED Modular	AV-03	LED Wall, Exhibition Wall	LED高海州郊社市路	Overall Size: 482mmW x 243mmD x 66.5mmH Quantity: 3		广东联合制造科技有限公司 梁建广 Tel: +86 13510842521 Email: leung21@yeah.net www.unite-mfg.com Address: 广东省深圳市宝安区 宝田二路2号臣田工业区28栋3层

Sheet No.: 6000

Lilliance	Wall allu Ga	niery Area		
Speaker	AV-04	Inside Atrium LED Wall	型號:C880 顏色: Black 安裝尺寸: Dia. 248mm 產品尺寸: Dia. 248 x 185mm 額定功率: 40W 最大功率: 60W 頻響: 85Hz-18KHz 靈敏度: 92dB	广东联合制造科技有限公司 梁建广 Tel: +86 13510842521 Email: leung21@yeah.net www.unite-mfg.com Address: 广东省深圳市宝安区 宝田二路2号臣田工业区28栋3层
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項目 ITEM	項目名稱 ITEM DESCRIPTION	位置圖號 LOCATION PLAN	設計圖號 DESIGN DRAWING		標誌內容清單 MESSAGE SCHEDULE	標誌類型 SIGN TYPE	需供電 ELECTRIC	中標後承包商需提交樣板 SAMPLE SUBMISSION	數量 QTY.	備註 REMARKS	DO NOT SCAI VERIFY ALL D	E DRAWINGS. IMENSIONS ON SITE.
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GA	Faculties ID	GLP - 01	HKCHC_SG_GA_01~03		Refer to Design Drawing	W-M	Yes	Sample section to Be Submitted	05	Content to be provided by client		
GB	Directory ID	GLP-01	HKCHC_SG_GB_01		CN:總指南 EN: Diretory	W-M	No	-	01			
GC	College Emblem	GLP - 01	HKCHC_SG_GC_01		-	W-M	No	Sample section to Be Submitted	01			
GD	Gallery ID	GLP-01	HKCHC_SG_GD_01		CN: 展覽 EN: Gallery	W-M	No	Sample section to Be Submitted	01			
GE	Present Zone ID	GLP-01	HKCHC_SG_GE_01~02		Refer to Design Drawing	W M	No		06	- Desgin Item Omit by Client		
GF	Present Zone Introduction	GLP-01	HKCHC_SG_GF_01		Refer to Design Drawing	S-K	No	-	02	Content to be provided by client		
GG	Past Zone ID	GLP-01	HKCHC_SG_GG_01~02	\\\\\\\\\\\\\\\\\\\\\\\\\\\\\\\\\\\\\	Refer to Design Drawing	W-M	No No	~~~~~~~~~~~~~~~~~~~~~~~~~~~~~~~~~~~~~	06		- 15/03/ REV DATE	24 FIRST ISSUE DRAFT DESCRIPTION
GH	Past Zone Introduction	GLP - 01	HKCHC_SG_GH_01	\ \ \ \ \ \ \ \ \ \ \ \ \ \ \ \ \ \ \ 	Refer to Design Drawing	S-K	No	-	02	Content to be provided by client	CLIENT	Hong Kong Chu Hai College
GI	Facade Graphic	GLP-01	HKCHC_SG_GI_01~02		-	W-M	No No	Sample section to Be Submitted	08	Client to confirm option		Chu Hai College of Higher Education, 80 Castle Peak Road, Castle Peak Bay, Tuen Mun, N.T. Hong Kong. TEL: (852) 2972-7200 FAX: (852) 297 Email: info@chuhai.edu.hk
GJ	Photo Frame	~~~~~~~~~~~~~~~~~~~~~~~~~~~~~~~~~~~~~	HKCHC_SG_GJ_01~02	\ \ \ \ \ \ \ \ \ \ \ \ \ \ \ \ \ \ \ 			No	~~~~~~~~~~~~~~~~~~~~~~~~~~~~~~~~~~~~~	.	Content inside photo frame	DESIGN ARCI	
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	L	-	Sign Locati	on Plan				
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	G	-	Gallery					
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Hong Kong Chu Hai Co**ll**ege



Horig Kung Chu i nar Concogo Chu Hai College of Higher Education, 80 Castle Peak Road, Castle Peak Bay, Tuen Mun, N.T. Hong Kong, TEL: (852) 2972-7200 [FAX: (852) 2972-7367 | Emalt: info@chuhai.edu.hk

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PROJECT MANAGER

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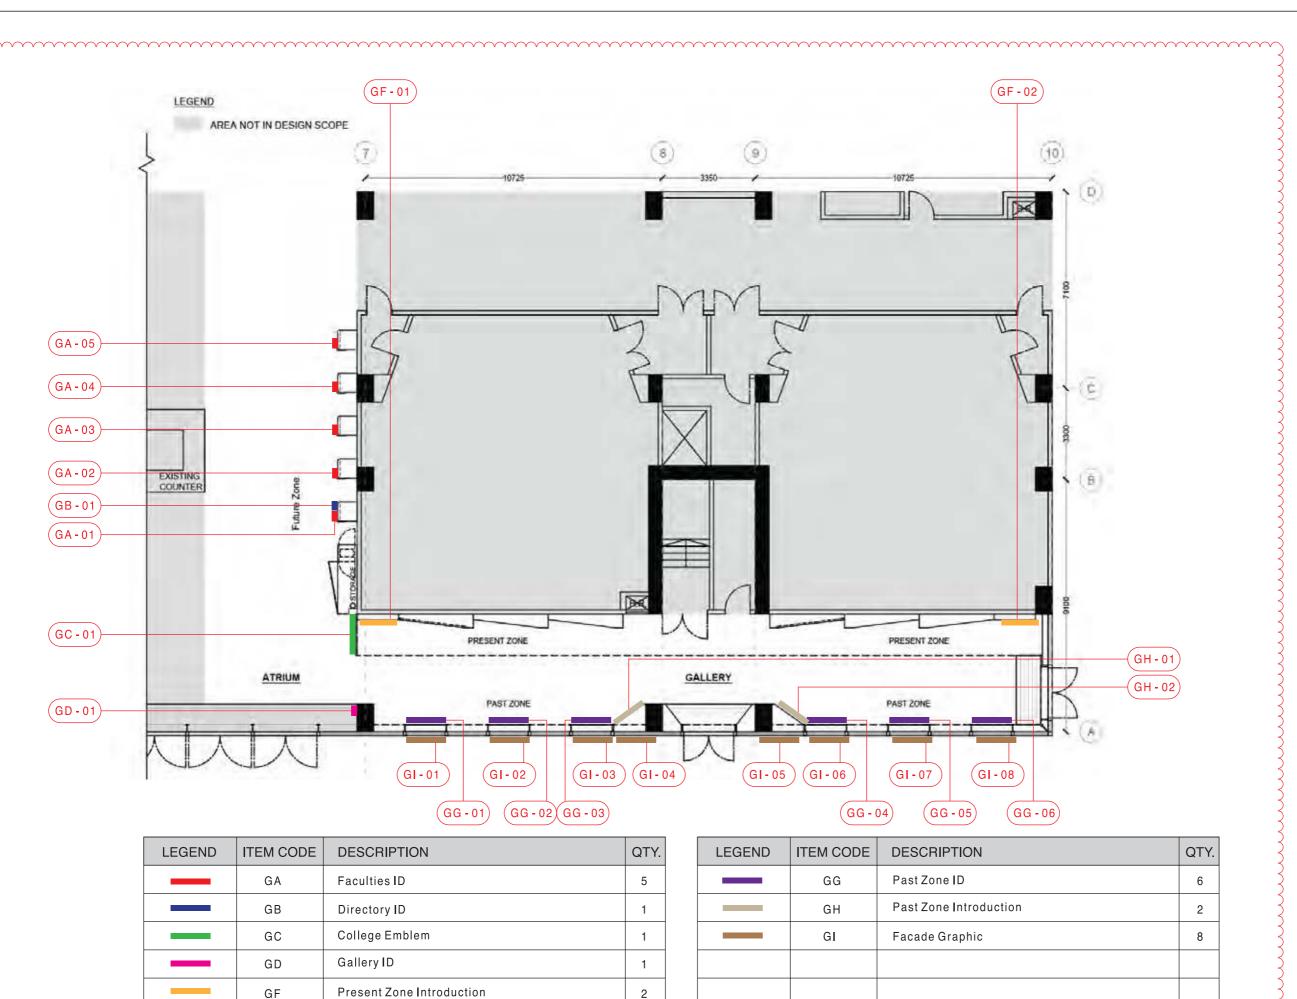
PROJECT

Hong Kong Chu Hai College Entrance Wall & Gallery Area

DRAWING TITLE Drawing List

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Hong Kong Chu Hai College



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Hong Kong Chu Hai College Entrance Wall & Gallery Area

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Signage and Graphic Location Plan

DRAWN BY	PL	DATE	27/03/2024
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NOTE

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Hong Kong Chu Hai College Entrance Wall & Gallery Area

DRAWING TIT

Summary Sign Schedule

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CHECKED BY		SCALE					
APPROVED BY	•	REVISION	-				
DWG NO.: HKCHC_SG_SSS_01							



Bead blasted piano black S.S (Ref. Cobelco CS-8883)



Bead blasted copper S.S (Ref. Cobelco CS-3017AFP)



white translucent acryic



3M™ Scotchcal™ Perforated Window Film IJ67



IP 65 LED Strip




Clear acrylic



Spot Colour (Coated): Cool Gray 11C



Spot Colour (Coated): PMS 356C

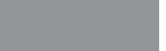

Spot Colour (Coated): PMS 442C

Spot Colour (Coated): PMS 661C



Spot Colour (Coated): PMS 425C



Spot Colour (Coated): PMS 3265C



Spot Colour (Coated): PMS 7544C



Spot Colour (Coated): PMS 2995C



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Hong Kong Chu Hai College



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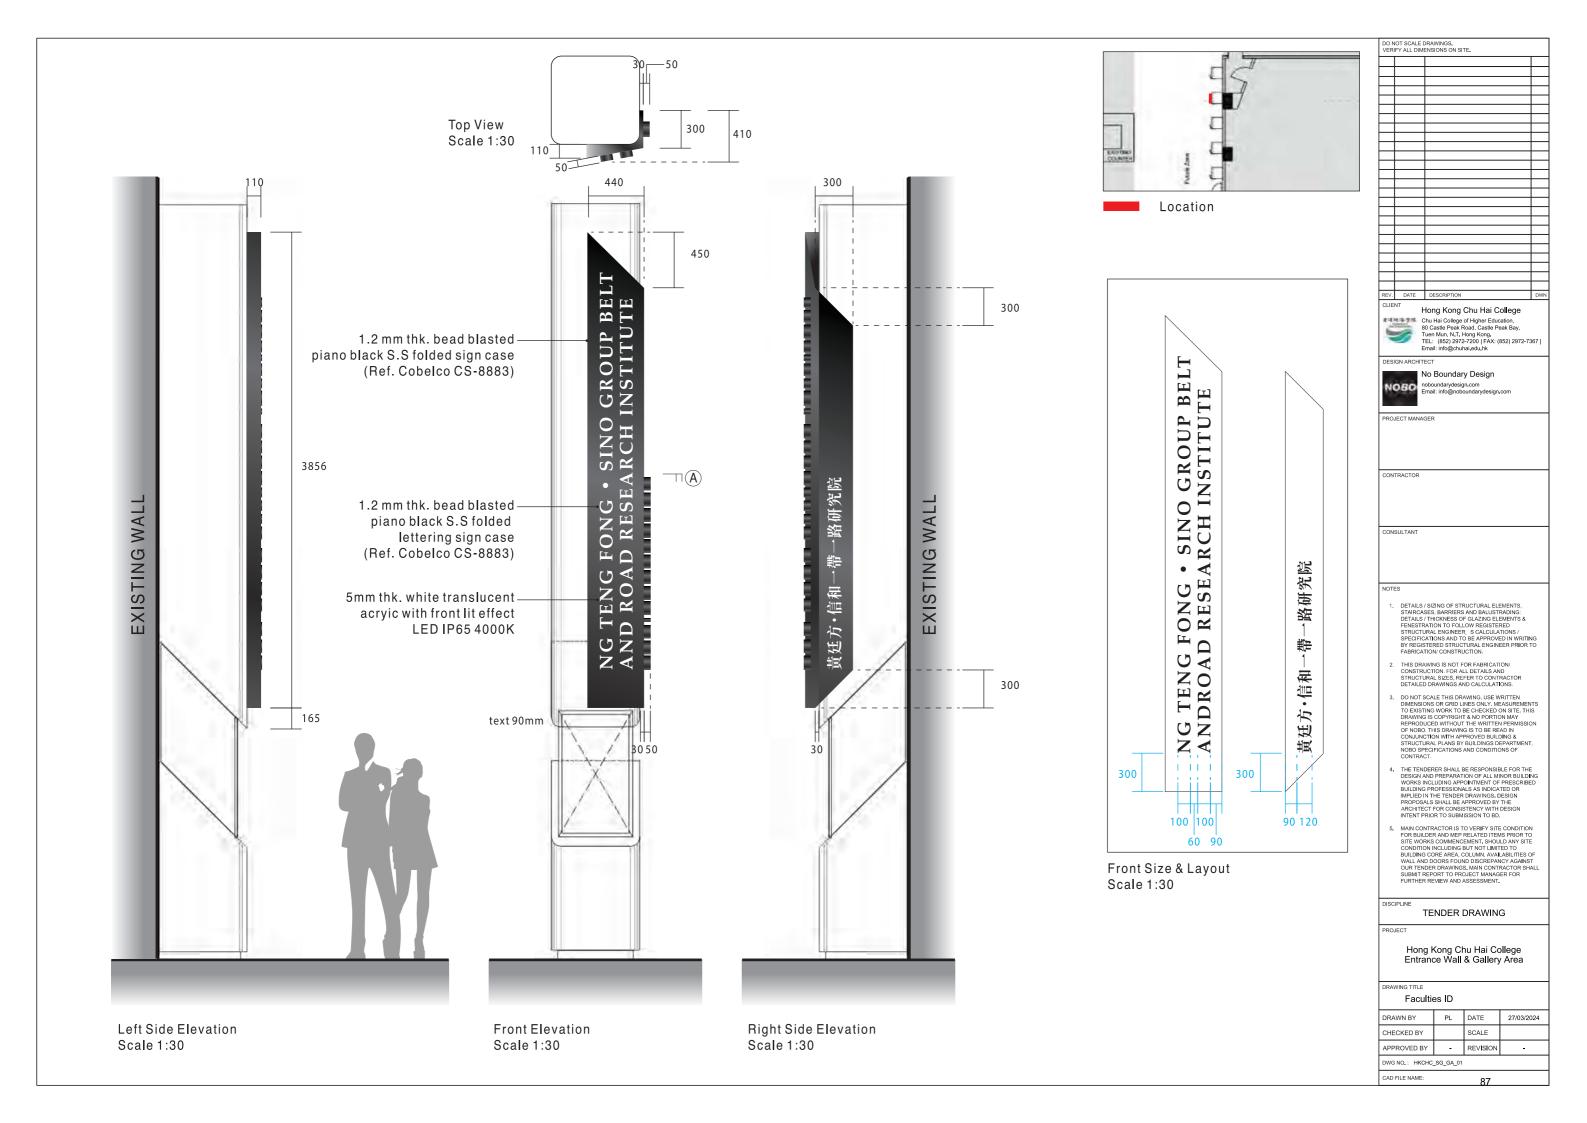
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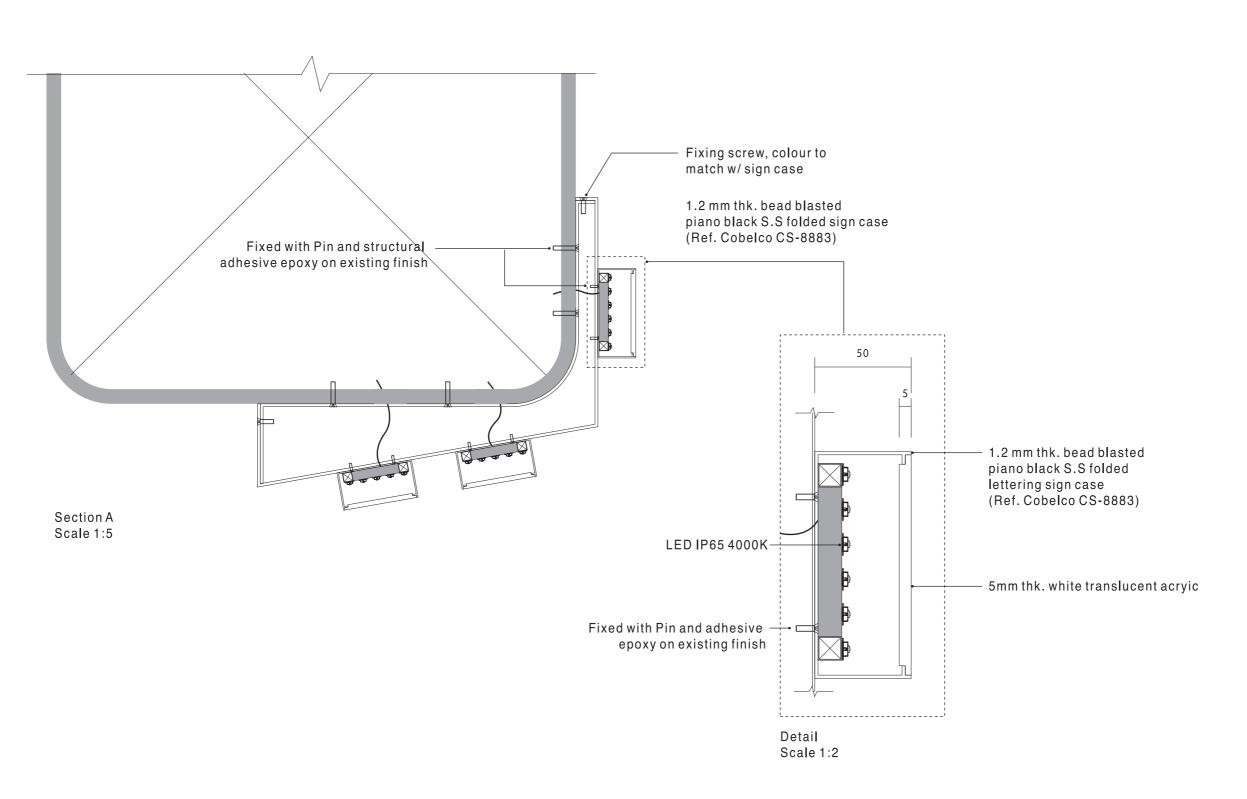
Hong Kong Chu Hai College Entrance Wall & Gallery Area

Material and Color Specifications

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APPROVED BY	-	REVISION	-

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Hong Kong Chu Hai College Entrance Wall & Gallery Area


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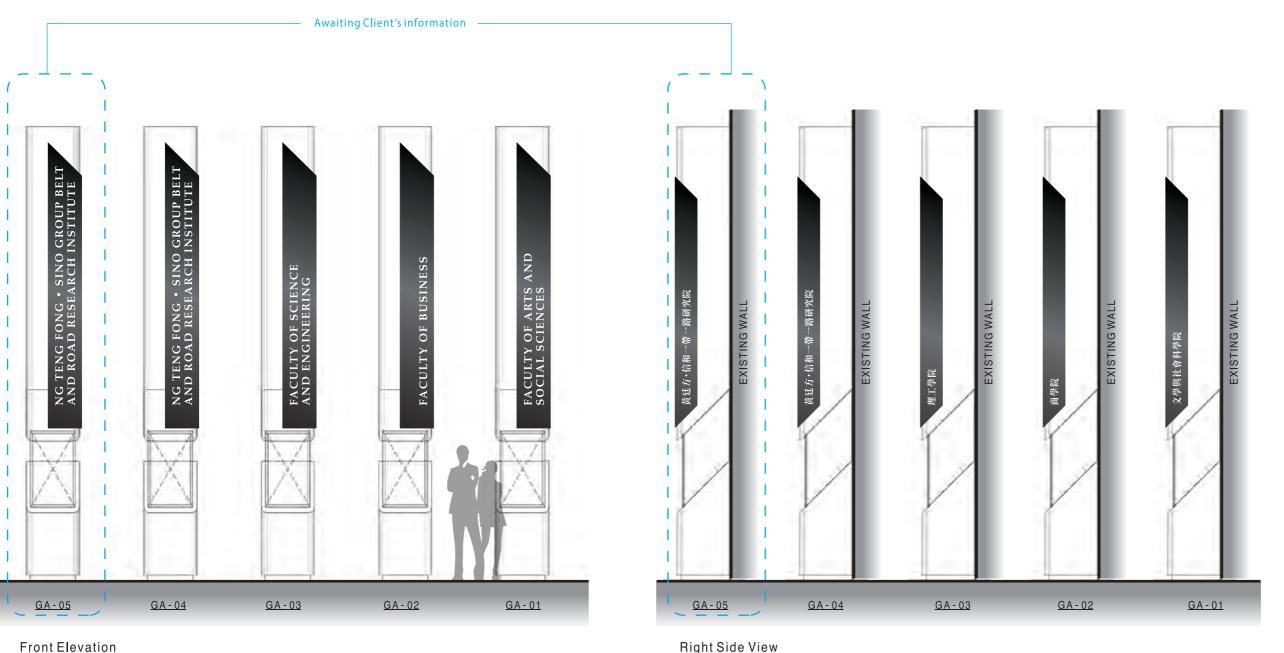
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DISCIPLINE

TENDER DRAWING


Hong Kong Chu Hai College Entrance Wall & Gallery Area

DRAWING TITLE

Faculties ID

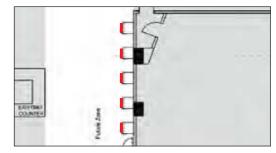DRAWN BY	PL	DATE	27/03/2024		
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APPROVED BY	-	REVISION	-		
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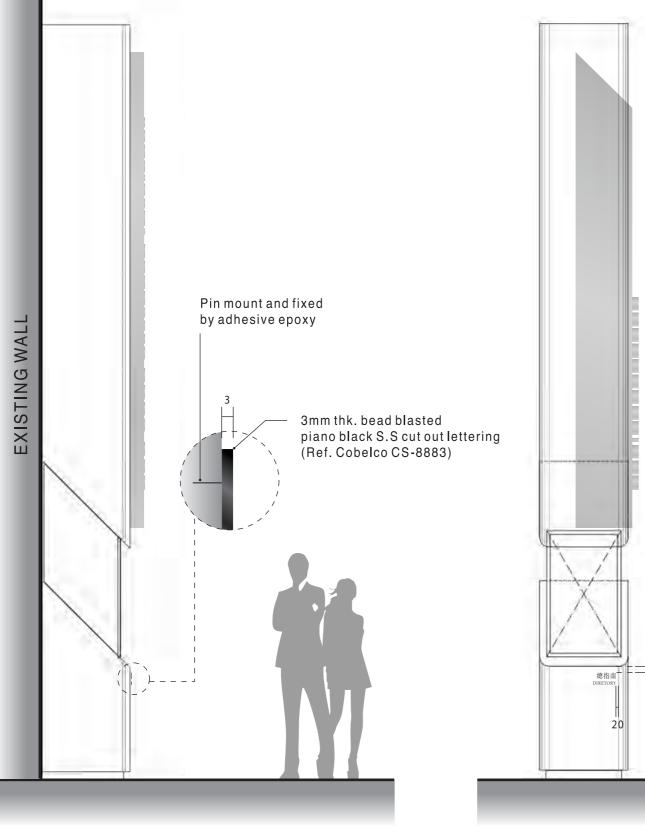
CAD FILE NAME:



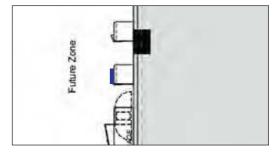

總指章 20 DIRECTORY 25

Front Size & Layout Scale 1:2



Left Side Elevation From Scale 1:30 Sca



REV. DATE DESCRIPTION CLIENT Hong Kong Chu Hai College Chu Hai College of Higher Education, Su Castle Peak Bay, Tuen Mun, N.T. Hong Kong, Tet: (852) 2972-730 [FAX: (852) 2972-73] Email: info@ohuhal.edu.hk DESIGN ARCHITECT NO Boundary Design noboundarydesign.com Email: info@noboundarydesign.com PROJECT MANAGER			DRAWINGS. MENSIONS O	N SITE.		
CLIENT Hong Kong Chu Hai College Chu Hai College of Higher Education, 80 Castle Peak Road, Castle Peak Bay, Tuen Mun, N.T. Hong Kong, TEL: (852) 2972-7200 FAX: (852) 2972-736 DESIGN ARCHITECT No Boundary Design noboundarydesign.com Email: info@noboundarydesign.com						Т
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NOTES

- DETAILS / SIZING OF STRUCTURAL ELEMENTS, STAIRCASES, BARRIERS AND BALUSTRADING: DETAILS / THICKNESS OF GLAZING ELEMENTS & FENESTRATION TO FOLLOW REGISTERED STRUCTURAL ENGINEER: S CALCULATIONS / SPECIFICATIONS AND TO BE APPROVED IN WRITING BY REGISTERED STRUCTURAL ENGINEER PRIOR TO FABRICATION / CONSTRUCTION.
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TENDER DRAWING

PROJEC

Hong Kong Chu Hai College Entrance Wall & Gallery Area


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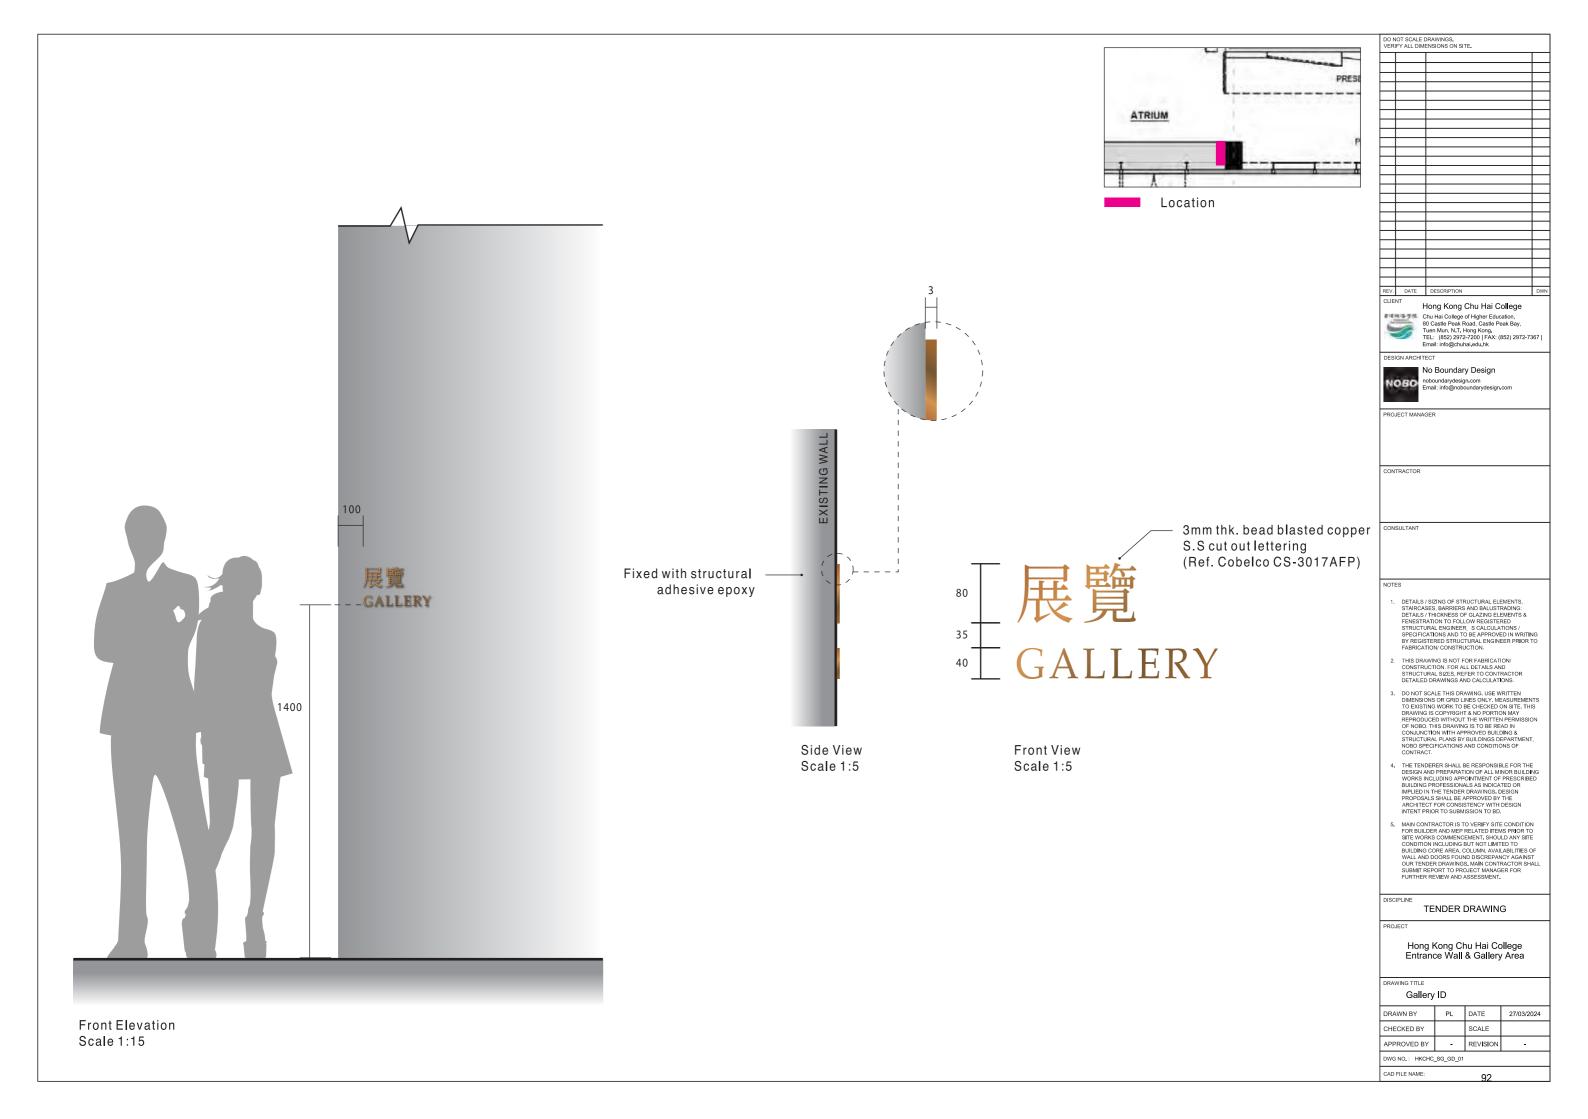
DRAWN BY	PL	DATE	27/03/2024
CHECKED BY		SCALE	
APPROVED BY	-	REVISION	-


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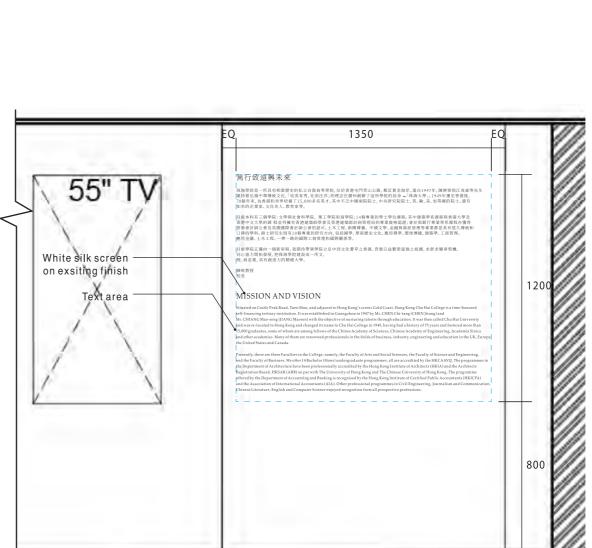
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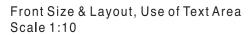
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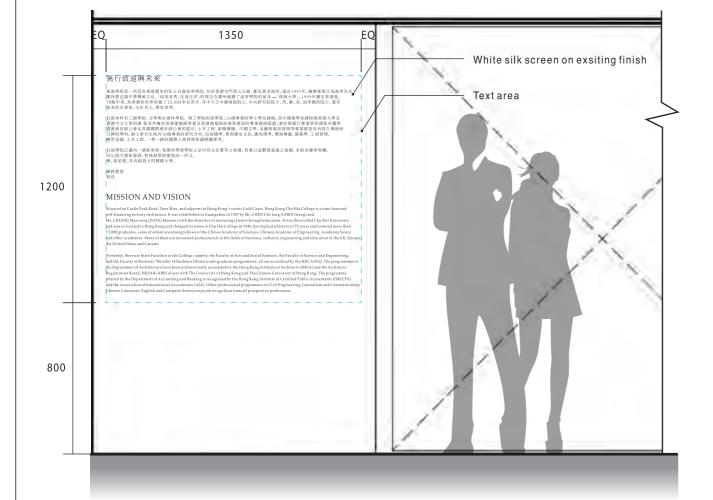








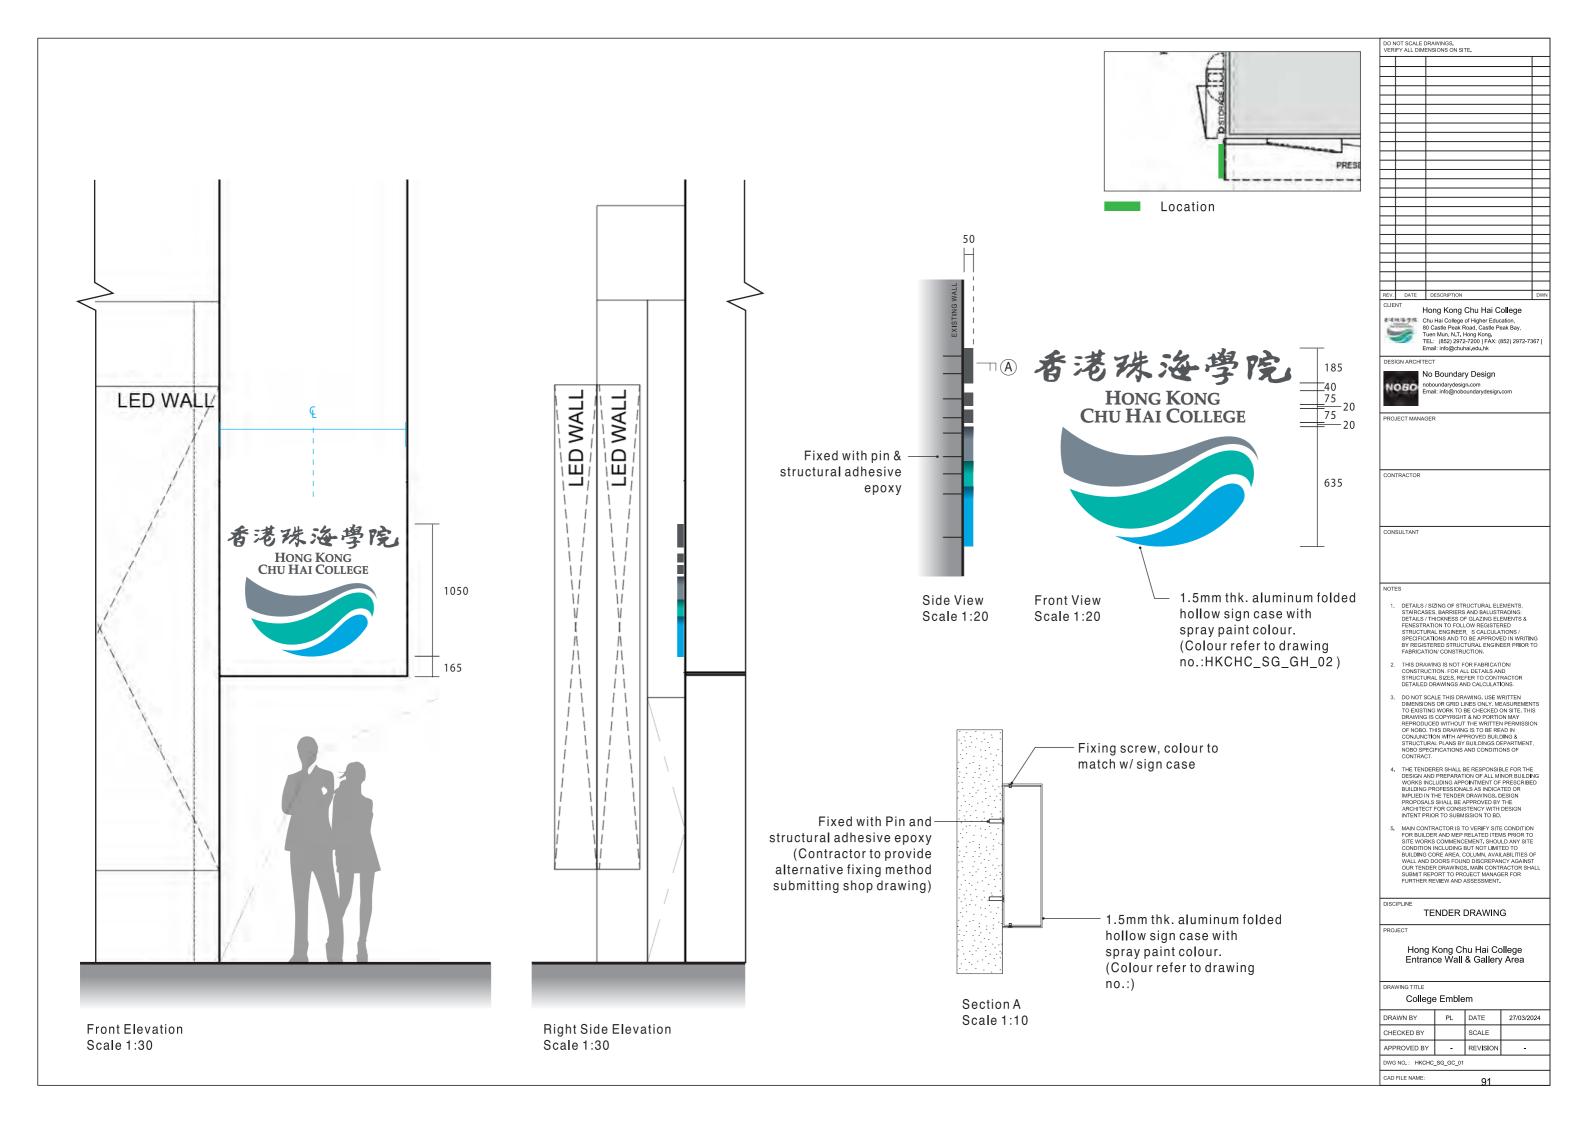

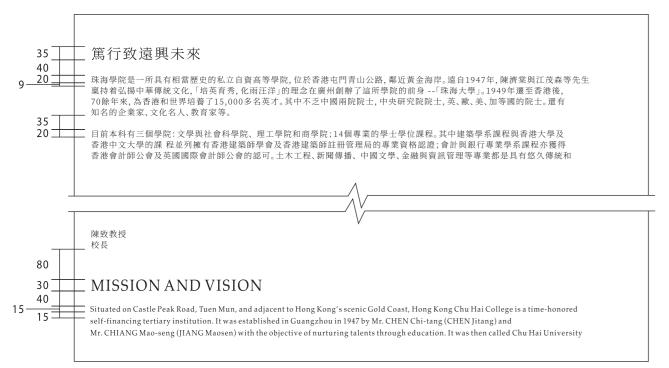

Front Elevation Scale 1:20

Front Elevation Scale 1:20

PRESENT ZONE PRESENT ZONE PAST ZONE PAST ZONE Location Location

*Content to be provided by client

OO NOT SCALE DRAWINGS. VERIFY ALL DIMENSIONS ON SITE. Hong Kong Chu Hai College

Tonig Tonig Online Tea Conege
Chu Hai College of Higher Education,
80 Castle Peak Road, Castle Peak Bay,
Tuen Mun, N.T. Hong Kong,
TEL: (852) 2972-7200 | FAX: (852) 2972-7367 |
Email: info@chuhai.edu.hk

DESIGN ARCHITECT



No Boundary Design

- I. DETAILS / SIZING OF STRUCTURAL ELEMENTS, STARCASES, BARRIERS AND BALUSTRADING: DETAILS / THICKNESS OF GLAZING ELEMENTS & FENESTRATION TO FOLLOW REGISTERED STRUCTURAL ENGINEER, S CALCULATIONS / SPECIFICATIONS AND TO BE APPROVED IN WRITING BY REGISTERED STRUCTURAL ENGINEER PRIOR TO FABRICATION! CONSTRUCTION.
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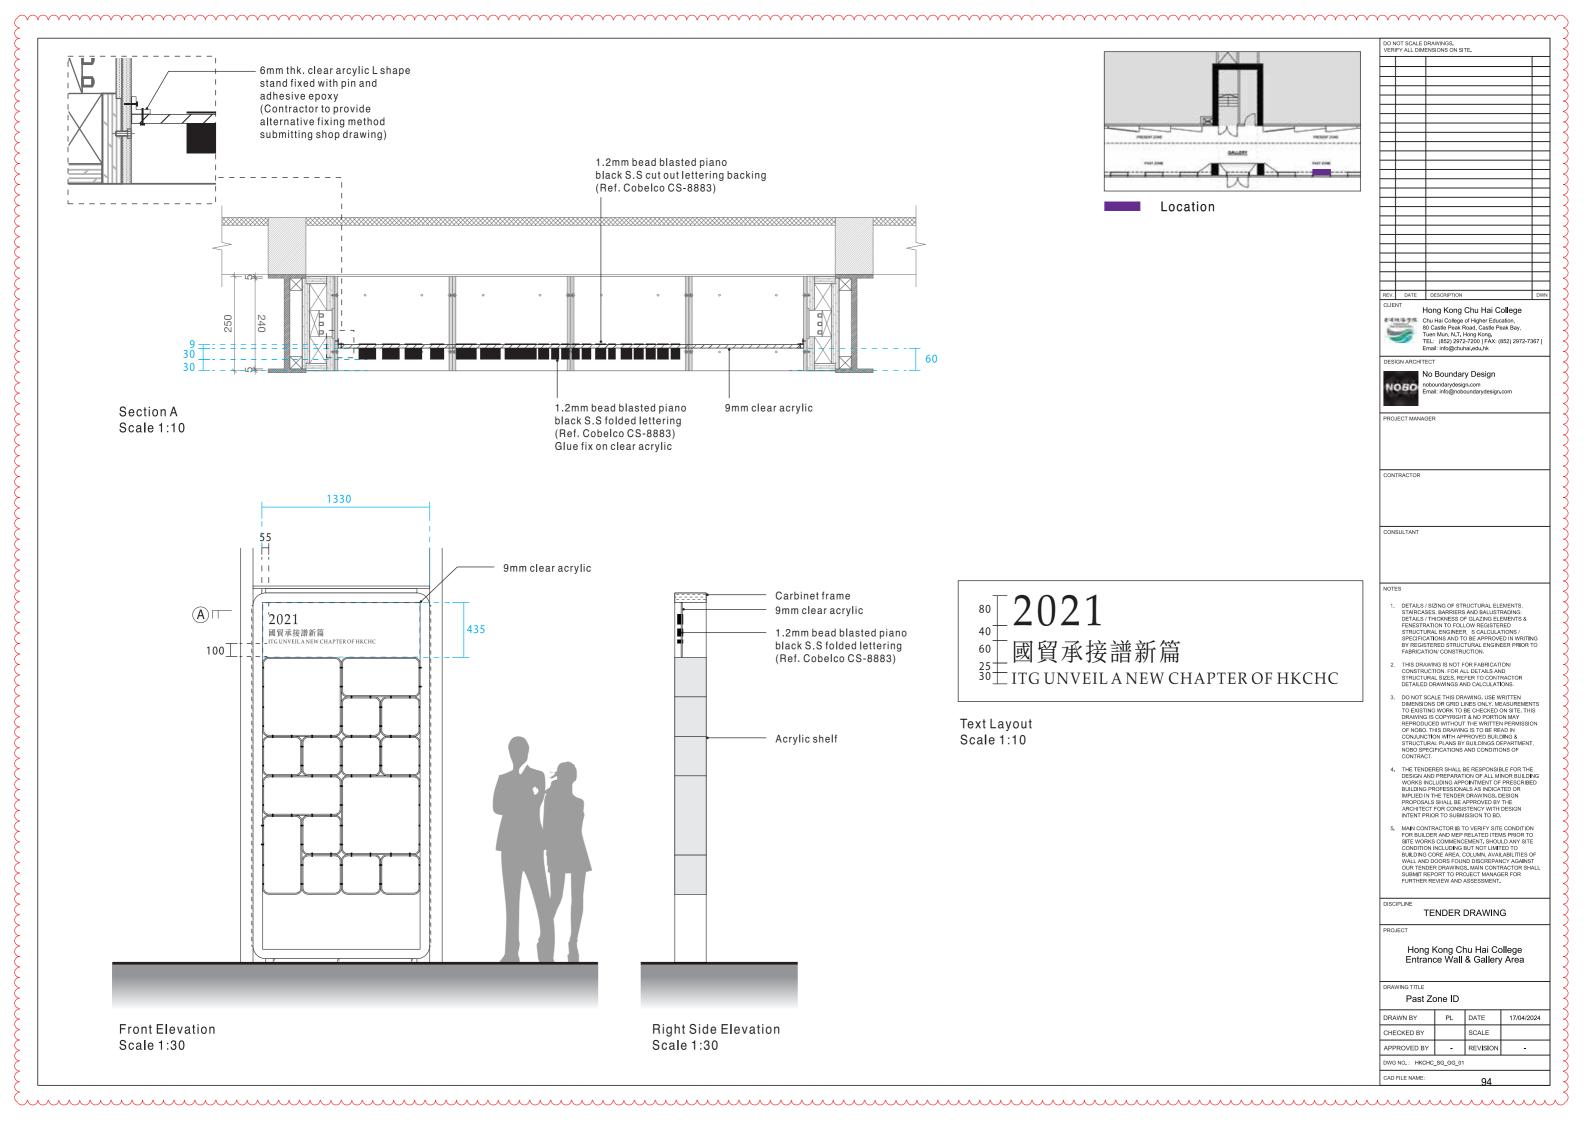
TENDER DRAWING


Hong Kong Chu Hai College Entrance Wall & Gallery Area


CAD FILE NAME:

Present Zone Introduction

DRAWN BY DATE 27/03/2024 CHECKED BY SCALE APPROVED BY REVISION DWG NO.: HKCHC_SG_GF_01



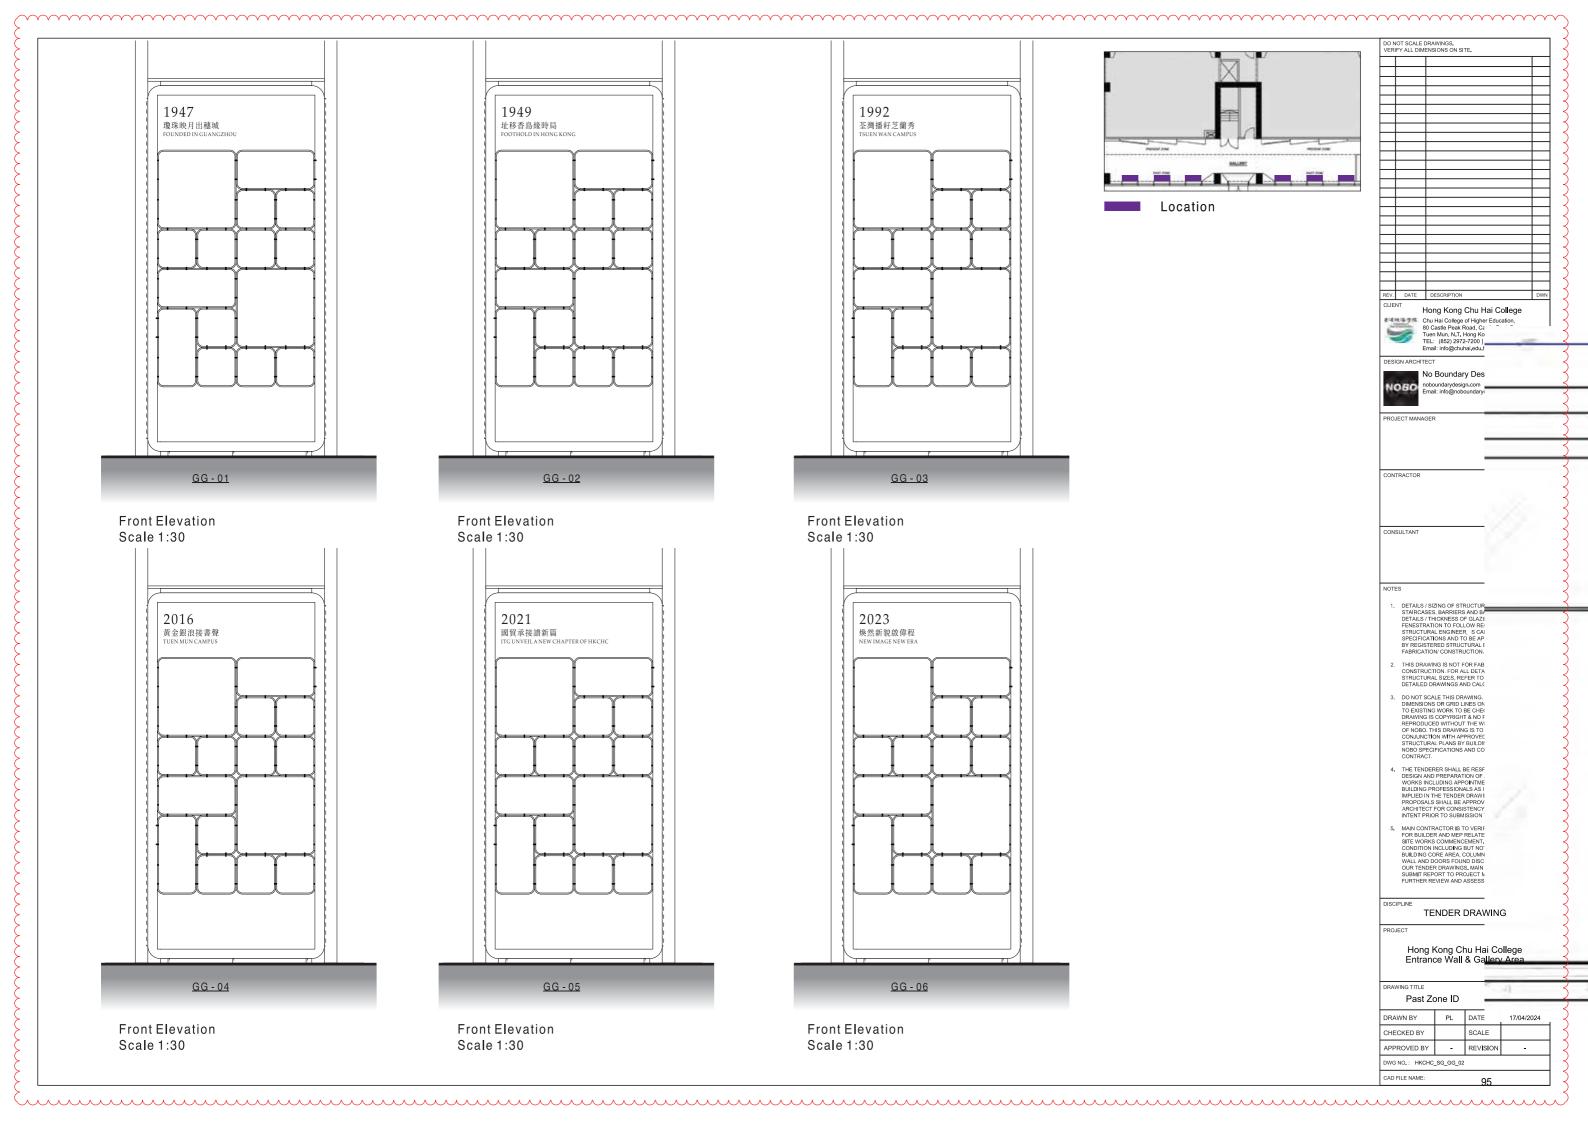

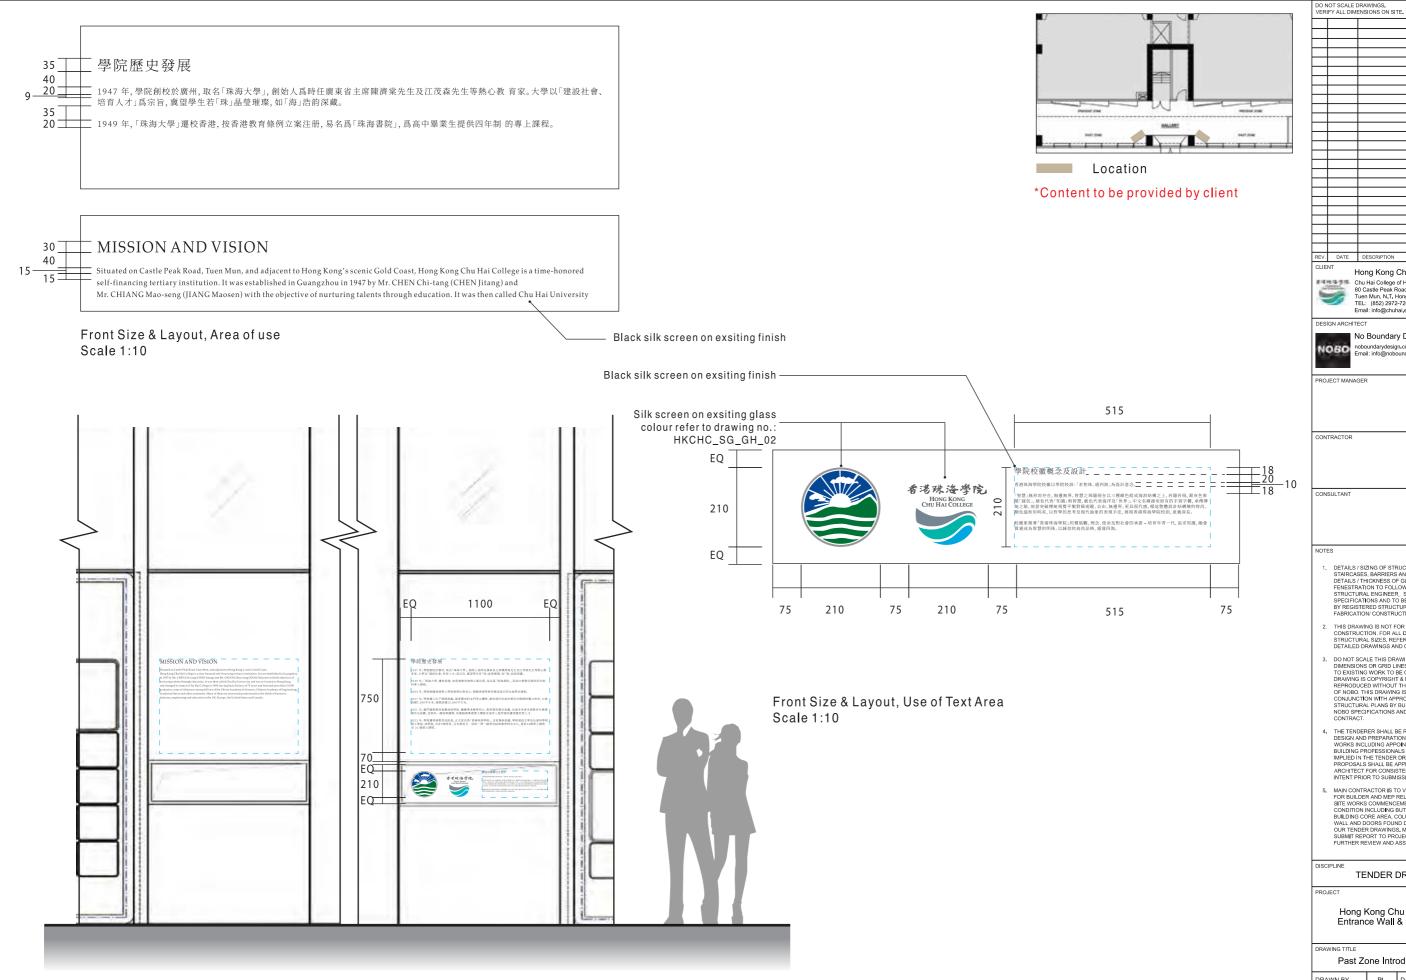

Front Elevation Scale 1:30

Tiong Tong Gin Tail College
Chu Hai College of Higher Education,
80 Castle Peak Road, Castle Peak Bay,
Tuen Mun, N.T. Hong Kong,
TEL: (852) 2972-7200 [FAX: (852) 2972-7367 |
Email: info@chuhai.edu.hk

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TENDER DRAWING

Hong Kong Chu Hai College Entrance Wall & Gallery Area

Past Zone Introduction

DRAWN BY	PL	DATE	27/03/2024		
CHECKED BY		SCALE			
APPROVED BY	-	REVISION	-		
DWG NO.: HKCHC_SG_GH_01					



Logo 02 PMS Colour



Spot Colour (Coated): Cool Gray 11C



Spot Colour (Coated): PMS 356C



Spot Colour (Coated): PMS 442C



Spot Colour (Coated): PMS 661C

Logo 02 PMS Colour



Spot Colour (Coated): PMS 425C



Spot Colour (Coated): PMS 3265C



Spot Colour (Coated): PMS 7544C



Spot Colour (Coated): PMS 2995C

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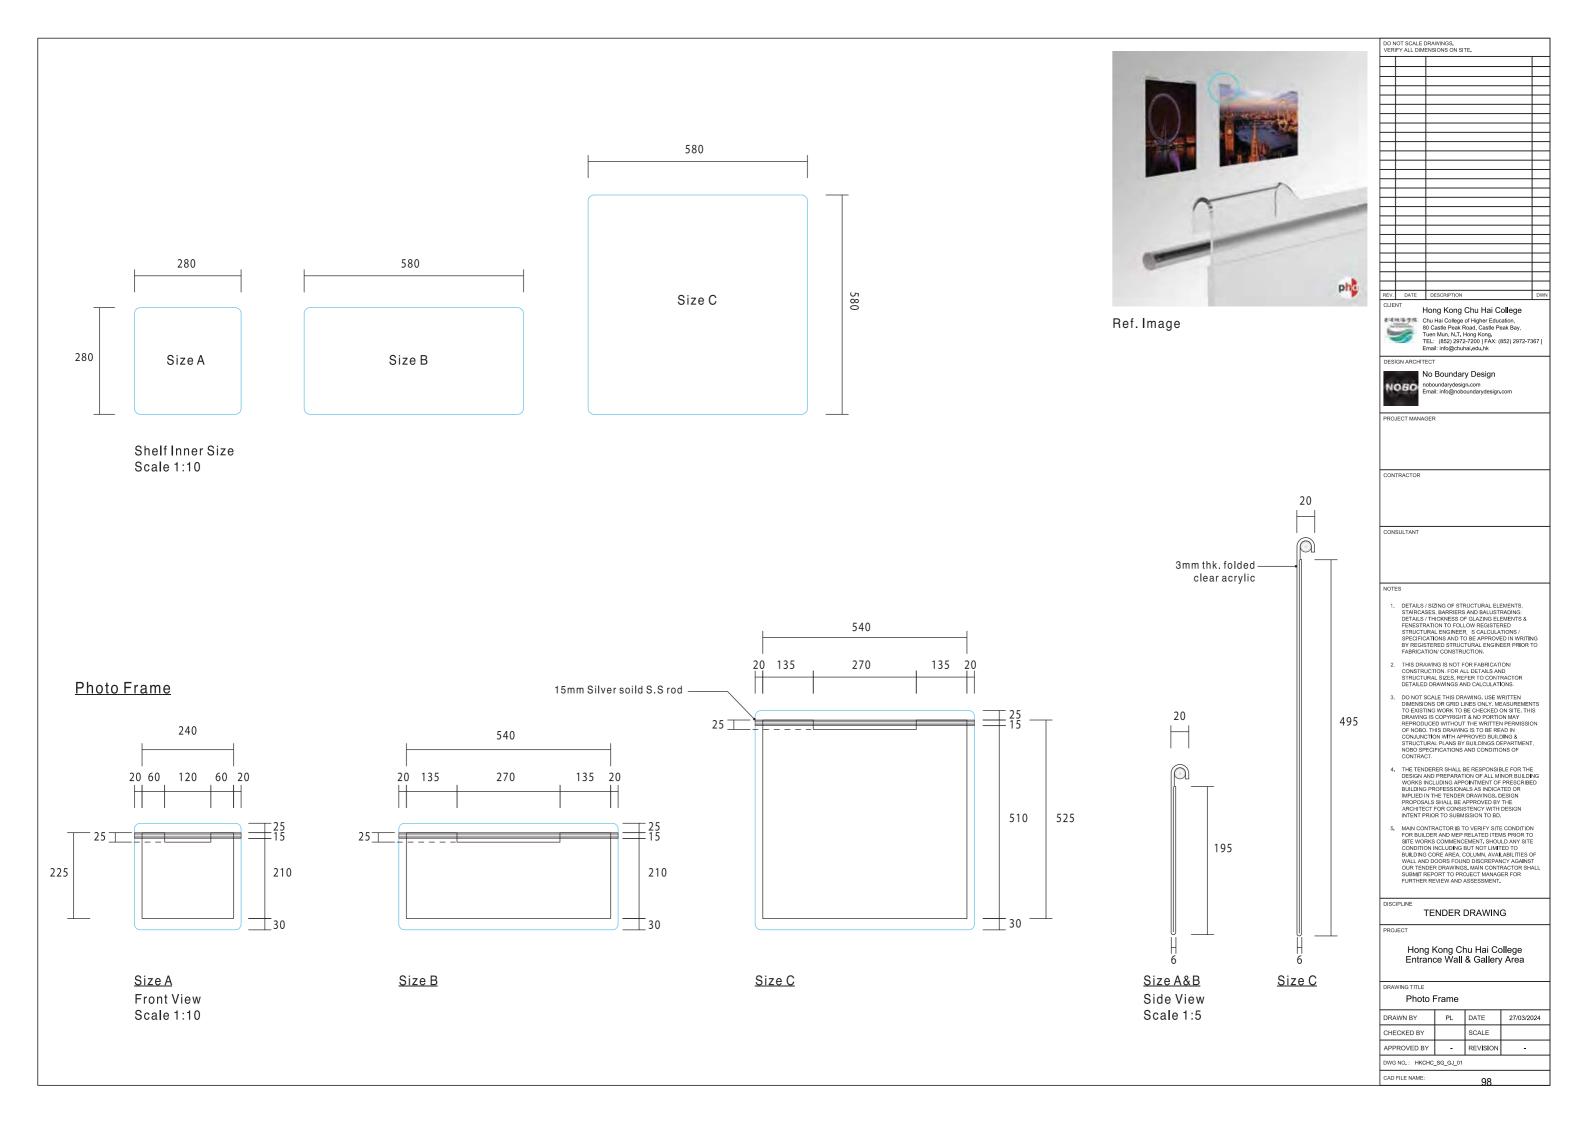
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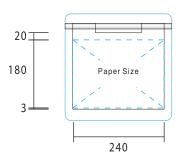
TENDER DRAWING

Hong Kong Chu Hai College Entrance Wall & Gallery Area


Past Zone Introduction

DRAWN BY DATE 27/03/2024 CHECKED BY SCALE APPROVED BY REVISION DWG NO.: HKCHC_SG_GH_02






<u>Size A</u> Front View Scale 1:10

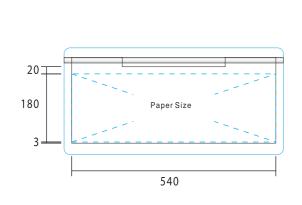

<u>Size B</u>

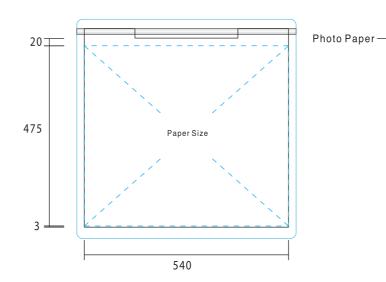

Size C

學院歷史發展

Paper Size



學院歷史發展 1949 年,「珠海大學」運校香港,按香港教育條例立案注册,易名為「珠海書院」, 馬為中畢業生提供四年制的專上課程。 2004年,學院根據香港專上學院條例注册成立、開齡香港學術評審局認可的 本地學位課程。 2023年、早院報告港教育局指准。正式更名爲「香港珠序學院」,並更換新校徽。 學院規設文學及社會科學院、 理工學院、資學院、共治河鎮學系,另有黃廷方·信和一帶一路研究院與 每學研究中人發性。每學士就養私 16 獨相士課程。



Area of use (Suggestion Only)

<u>Size A</u>

Scale 1:10

Size B

Size C

*Please note content to be created and provided by client

TENDER DRAWING

DO NOT SCALE DRAWINGS. VERIFY ALL DIMENSIONS ON SITE.

REV. DATE

DESIGN ARCHITECT

Hong Kong Chu Hai College Chu Hai College of Higher Education, 80 Castle Peak Road, Castle Peak Bay, Tuen Mun, N.T. Hong Kong. TEL: (852) 2972-7200 | FAX: (852) 2972-7367 | Email: info@chuhai.edu.hk

No Boundary Design

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Hong Kong Chu Hai College Entrance Wall & Gallery Area

DRAWING TITLE

CAD FILE NAME:

DISCIPLINE

Photo Frame DRAWN BY DATE 27/03/2024 CHECKED BY SCALE APPROVED BY REVISION

DWG NO.: HKCHC_SG_GJ_02

Banner PMS Colours



Spot Colour (Coated): PMS 7544C



Spot Colour (Coated): PMS 3265C




Spot Colour (Coated): PMS 2995C


*Contractor to match PMS colour in CMYK printing process



*Contractor to measure out above red area indicated in photo. Cut out facade banner to aviod covering Jocky club academic tower logo. Contractor to provide measurement and drawing in shop drawing for client's approval.

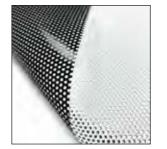


Ref. Image: 3M™ Scotchcal™ Perforated Window Film IJ67

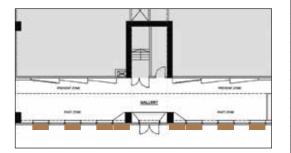

Location

*Contractor must provide exact measurement in shop drawing. Client to confirm option.

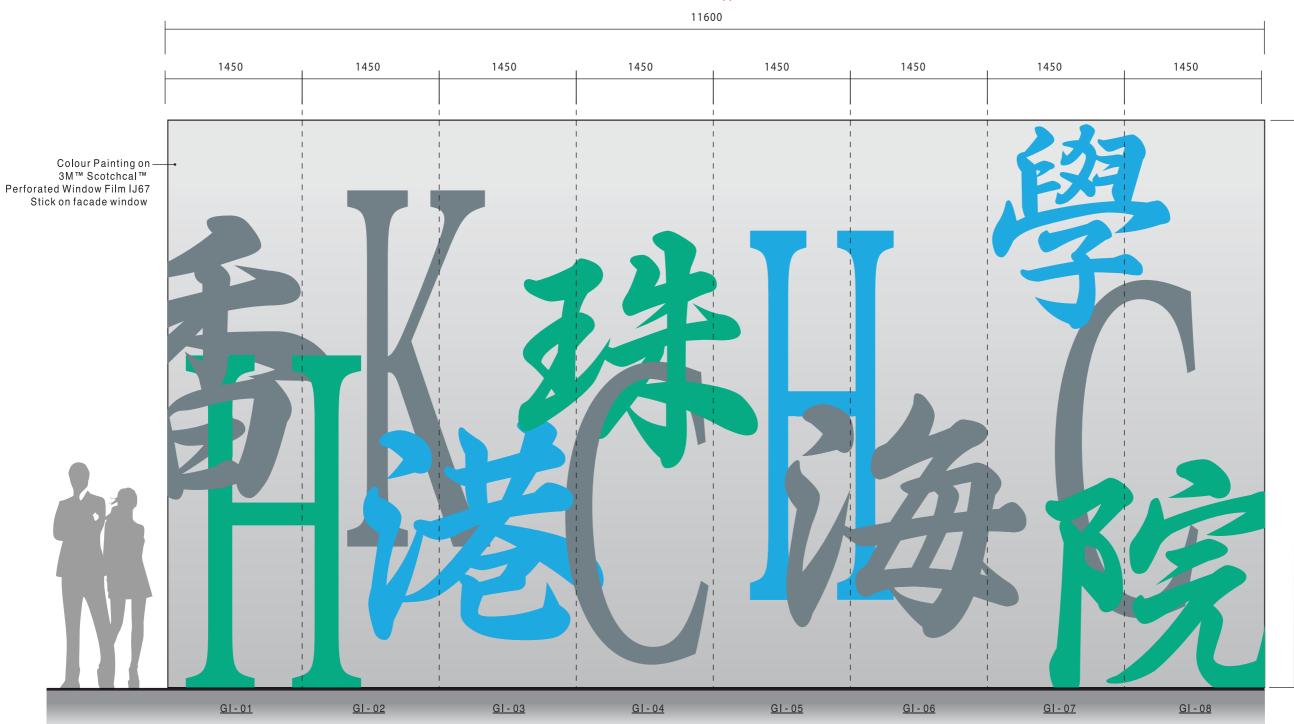

Front Elevation Scale 1:40

DATE DESCRIPTION DW

CLIENT Hong Kong Chu Hai College

Chu Hai College of Higher Education,
80 Castle Peak Road, Castle Peak Bay,
Tuen Mun, N.T. Hong Kong,
TEL: (852) 9727-2700 | FAX: (852) 2972-7367 |
Email: info@chuhal.edu.hk

DESIGN ARCHITECT

No Boundary Design
noboundarydesign.com

Email: info@noboundarydesign.com

OO NOT SCALE DRAWINGS. VERIFY ALL DIMENSIONS ON SITE.

CONTRACTOR		

CONSULTANT

N

- DETAILS / SIZING OF STRUCTURAL ELEMENTS, STAIRCASES, BARRIERS AND BALUSTRADING: DETAILS / THICKNESS OF GLAZING ELEMENTS & FENESTRATION TO FOLLOW REGISTERED STRUCTURAL ENGINEER, SCALCULATIONS / SPECIFICATIONS AND TO BE APPROVED IN WRITING BY REGISTERED STRUCTURAL ENGINEER PRIOR TO FABRICATION CONSTRUCTION.
- THIS DRAWING IS NOT FOR FABRICATION/ CONSTRUCTION. FOR ALL DETAILS AND STRUCTURAL SIZES, REFER TO CONTRACTOR DETAILED DRAWINGS AND CALCULATIONS.
- DE PRACEJ DRAWINGS AND CACOURTIONS.

 DI NOT SCALE THIS DRAWING, USE WRITTEN DIMENSIONS OR GRID LINES ONLY. MEASUREMENTS TO EXISTING WORK TO BE CHECKED ON SITE. THIS DRAWING IS COPYRIGHT AN OP PORTION MAY REPRODUCED WITHOUT THE WRITTEN PERMISSION OF NOBO. THIS DRAWING IS TO BE READ IN CONJUNCTION WITH APPROVED BUILDING & STRUCTURAL PLANS BY BUILDINGS DEPARTMENT, NOBO SPECIFICATIONS AND CONDITIONS OF CONTRACT.
- 4. THE TENDERER SHALL BE RESPONSIBLE FOR THE DESIGN AND PREPARATION OF ALL MINOR BUILDING WORKS INCLUDING APPOINTMENT OF PRESCRIBED BUILDING PROFESSIONALS AS INDICATED OR IMPLEDIN THE TENDER DRAWINGS. DESIGN PROPOSALS SHALL BE APPROVED BY THE ARCHITECT FOR CONSISTENCY WITH DESIGN INTENT PRIOR TO SUBMISSION TO BO.
- IN IENI PRIOR TO SUBMISSION TO BU.

 5. MAIN CONTRACTOR IS TO VERIFY SITE CONDITION FOR BUILDER AND MEP RELATED ITEMS PRIOR TO SITE WORKS COMMENCEMENT. SHOULD ANY SITE CONDITION INCLUDING BUT NOT LIMITED TO BUILDING CORE AREA, COLUMN, AVALABILITIES OF WALL AND DOORS FOUND DISCREPANCY AGAINST OUR TENDER DRAWINGS, MAIN CONTRACTOR SHAL SUBMIT REPORT TO PROJECT MANAGER FOR FURTHER REVIEW AND ASSESSMENT.

CIPLINE	
	TENDER DRAWING

PROJECT

Hong Kong Chu Hai College Entrance Wall & Gallery Area

DRAWING TITLE

Facade Graphic (OPT 01)

DRAWN BY	PL	DATE	17/04/2024		
CHECKED BY		SCALE			
APPROVED BY	-	REVISION	-		
DWG NO.: HKCHC_SG_GI_0I					

100

Banner PMS Colours








C: 0 M:0 Y:0 K:90

*Contractor to match PMS colour in CMYK printing process


Spot Colour (Coated): PMS 7544C C: 0 M:0 Y:0 K:60



*Contractor to measure out above red area indicated in photo. Cut out facade banner to aviod covering Jocky club academic tower logo. Contractor to provide measurement and drawing in shop drawing for client's approval.

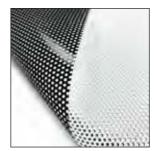

Ref. Image: 3M™ Scotchcal™ Perforated Window Film IJ67

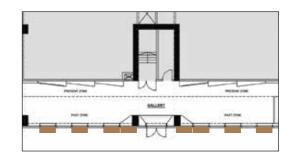

Location

*Contractor must provide exact measurement in shop drawing. Client to confirm option.



Front Elevation Scale 1:40

Chu Hai College of Higher Education, 80 Castle Peak Road, Castle Peak Bay, Tuen Mun, N.T. Horg Kong, TEL: (852) 2972-7200 | FAX: (852) 2972-7367 | Emalt: info@chuhal.edu.hk DESIGN ARCHITECT No Boundary Design

Hong Kong Chu Hai College

OO NOT SCALE DRAWINGS. VERIFY ALL DIMENSIONS ON SITE.

- DETAILS / SIZING OF STRUCTURAL ELEMENTS, STAIRCASES, BARRIERS AND BALUSTRADING: DETAILS / THICKNESS OF GLAZING ELEMENTS & FENESTRATION TO FOLLOW REGISTERED STRUCTURAL ENGINEER: SCALCULATIONS / SPECIFICATIONS AND TO BE APPROVED IN WRITING BY REGISTERED STRUCTURAL ENGINEER PRIOR TO FABRICATION CONSTRUCTION,
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 OUR TENDER DRAWINGS, MAIN CONTRACTOR SHAL
 SUBMIT REPORT TO PROJECT MANAGER FOR
 FURTHER REVIEW AND ASSESSMENT.

TENDER DRAWING

Hong Kong Chu Hai College Entrance Wall & Gallery Area

Facade Graphic (OPT 02)

DRAWN BY	PL	DATE	17/04/2024
CHECKED BY		SCALE	
APPROVED BY	-	REVISION	-
DWG NO,: HKCHC_SG_GI_02			

CAD FILE NAME:

101